Appendix 5.2

Summary Drawings

Appendix 5.2 Summary Drawings

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29043CD000 – Site Location Map
29043CD001 - Existing Drainage Layout
29043CD002 - Existing Site Plan
29043CD003 - Proposed Site Plan
29043CD014 - Proposed Drainage Layout 1 of 5
29043CD015 - Proposed Drainage Layout 2 of 5
29043CD016 - Proposed Drainage Layout 3 of 5
29043CD017 - Proposed Drainage Layout 4 of 5
29043CD018 - Proposed Drainage Layout 5 of 5
29043CD019 - Natural Drainage GA
29043CD201 - Proposed Tank Farm Layout
29043CD301 - Proposed Tanker Unloading Bay & Access Steps GA
29043CD401 - Proposed Warehouse, Workshop & ERT GA
29043CD501 - Proposed Bottom Ash Storage Building Ground Floor GA
29043CD601 - Proposed Hydrogen Generation unit (HGU) Building Ground
Floor GA
29043CD701 - Proposed Office Building Ground Floor GA
29043CD801 - Proposed Ash Unloading Area Canopy GA
29043CD1101 - Construction Stage Plan Phase 1 Sites & Contractors Compound
29043CD1102 - Construction Stage Plan Phase 2 Sites & Contractors Compound
```

SITE LOCATION MAP SCALE 1:2000

2. PROPOSED CONCRETE AREA FOR TANKER/TRUCK/CONTAINER PARKING (AREA C) 2a. PROPOSED NEW CONCRETE YARD AREA (AREA C) 3. PROPOSED CANOPY OVER MAINTENANCE BAY 4. PROPOSED WORKSHOP & OFFICE (AREA D) 5. PROPOSED WAREHOUSE (AREA D)

1. PROPOSED BOTTOM ASH STORAGE BUILDING (AREA B)

- 6. PROPOSED CAST CONCRETE HARDSTAND 7. PROPOSED TARMAC TRUCK REVERSING AREA
- 8. PROPOSED TANK FARM (AREA A) 9. PROPOSED TANKER UNLOADING AREA
- 10. PROPOSED ROAD WIDENING

- 11. PROPOSED CONCRETE YARD WIDENING 12. PROPOSED TRUCK LAYBY
- 13. PROPOSED CONCRETE FOOTPATH & STAIRS
- 14. PROPOSED OFFICE RE-BUILD (AREA G)
- 15. PROPOSED HYDROGEN GENERATION UNIT (AREA F) 16. PROPOSED ACCESS ROAD
- 17. PROPOSED CONTRACTORS LAYDOWN AREA 18. PROPOSED ALTERATION TO EXISTING CAR PARK (AREA H)

19. PROPOSED CANOPY OVER PRE-TREATMENT ACCESS AREA

NOTES

DENOTES EXTENT OF CURRENT PLANNING APPLICATION

DENOTES EXTENT OF LANDS OWNED BY INDAVER

Digital Cartographic Model (DCM)

Publisher / Source:

Ordnance Survey Ireland (OSi) Data Source / Reference:

File Format:

Autodesk AutoCAD (DWG_R2013)

File Name: v_50124237_1.dwg

Clip Extent / Area of Interest (AOI):

LLX,LLY= 705957.5,770425.1562

LRX,LRY= 706572.5,770425.1562 ULX,ULY= 705957.5,771255.1562 URX,URY= 706572.5,771255.1562

Projection / Spatial Reference:

Projection=IRENET95_Irish_Transverse_Mercator

Centre Point Coordinates: X,Y= 706265.0,770840.1562

Reference Index: Map Series | Map Sheets

1:2,500 | 2381-D 1.2,500 | 2443-B

Data Extraction Date:

Date= 16-Jun-2020 Source Data Release:

DCLMS Release V1.129.109

Product Version: Version= 1.3

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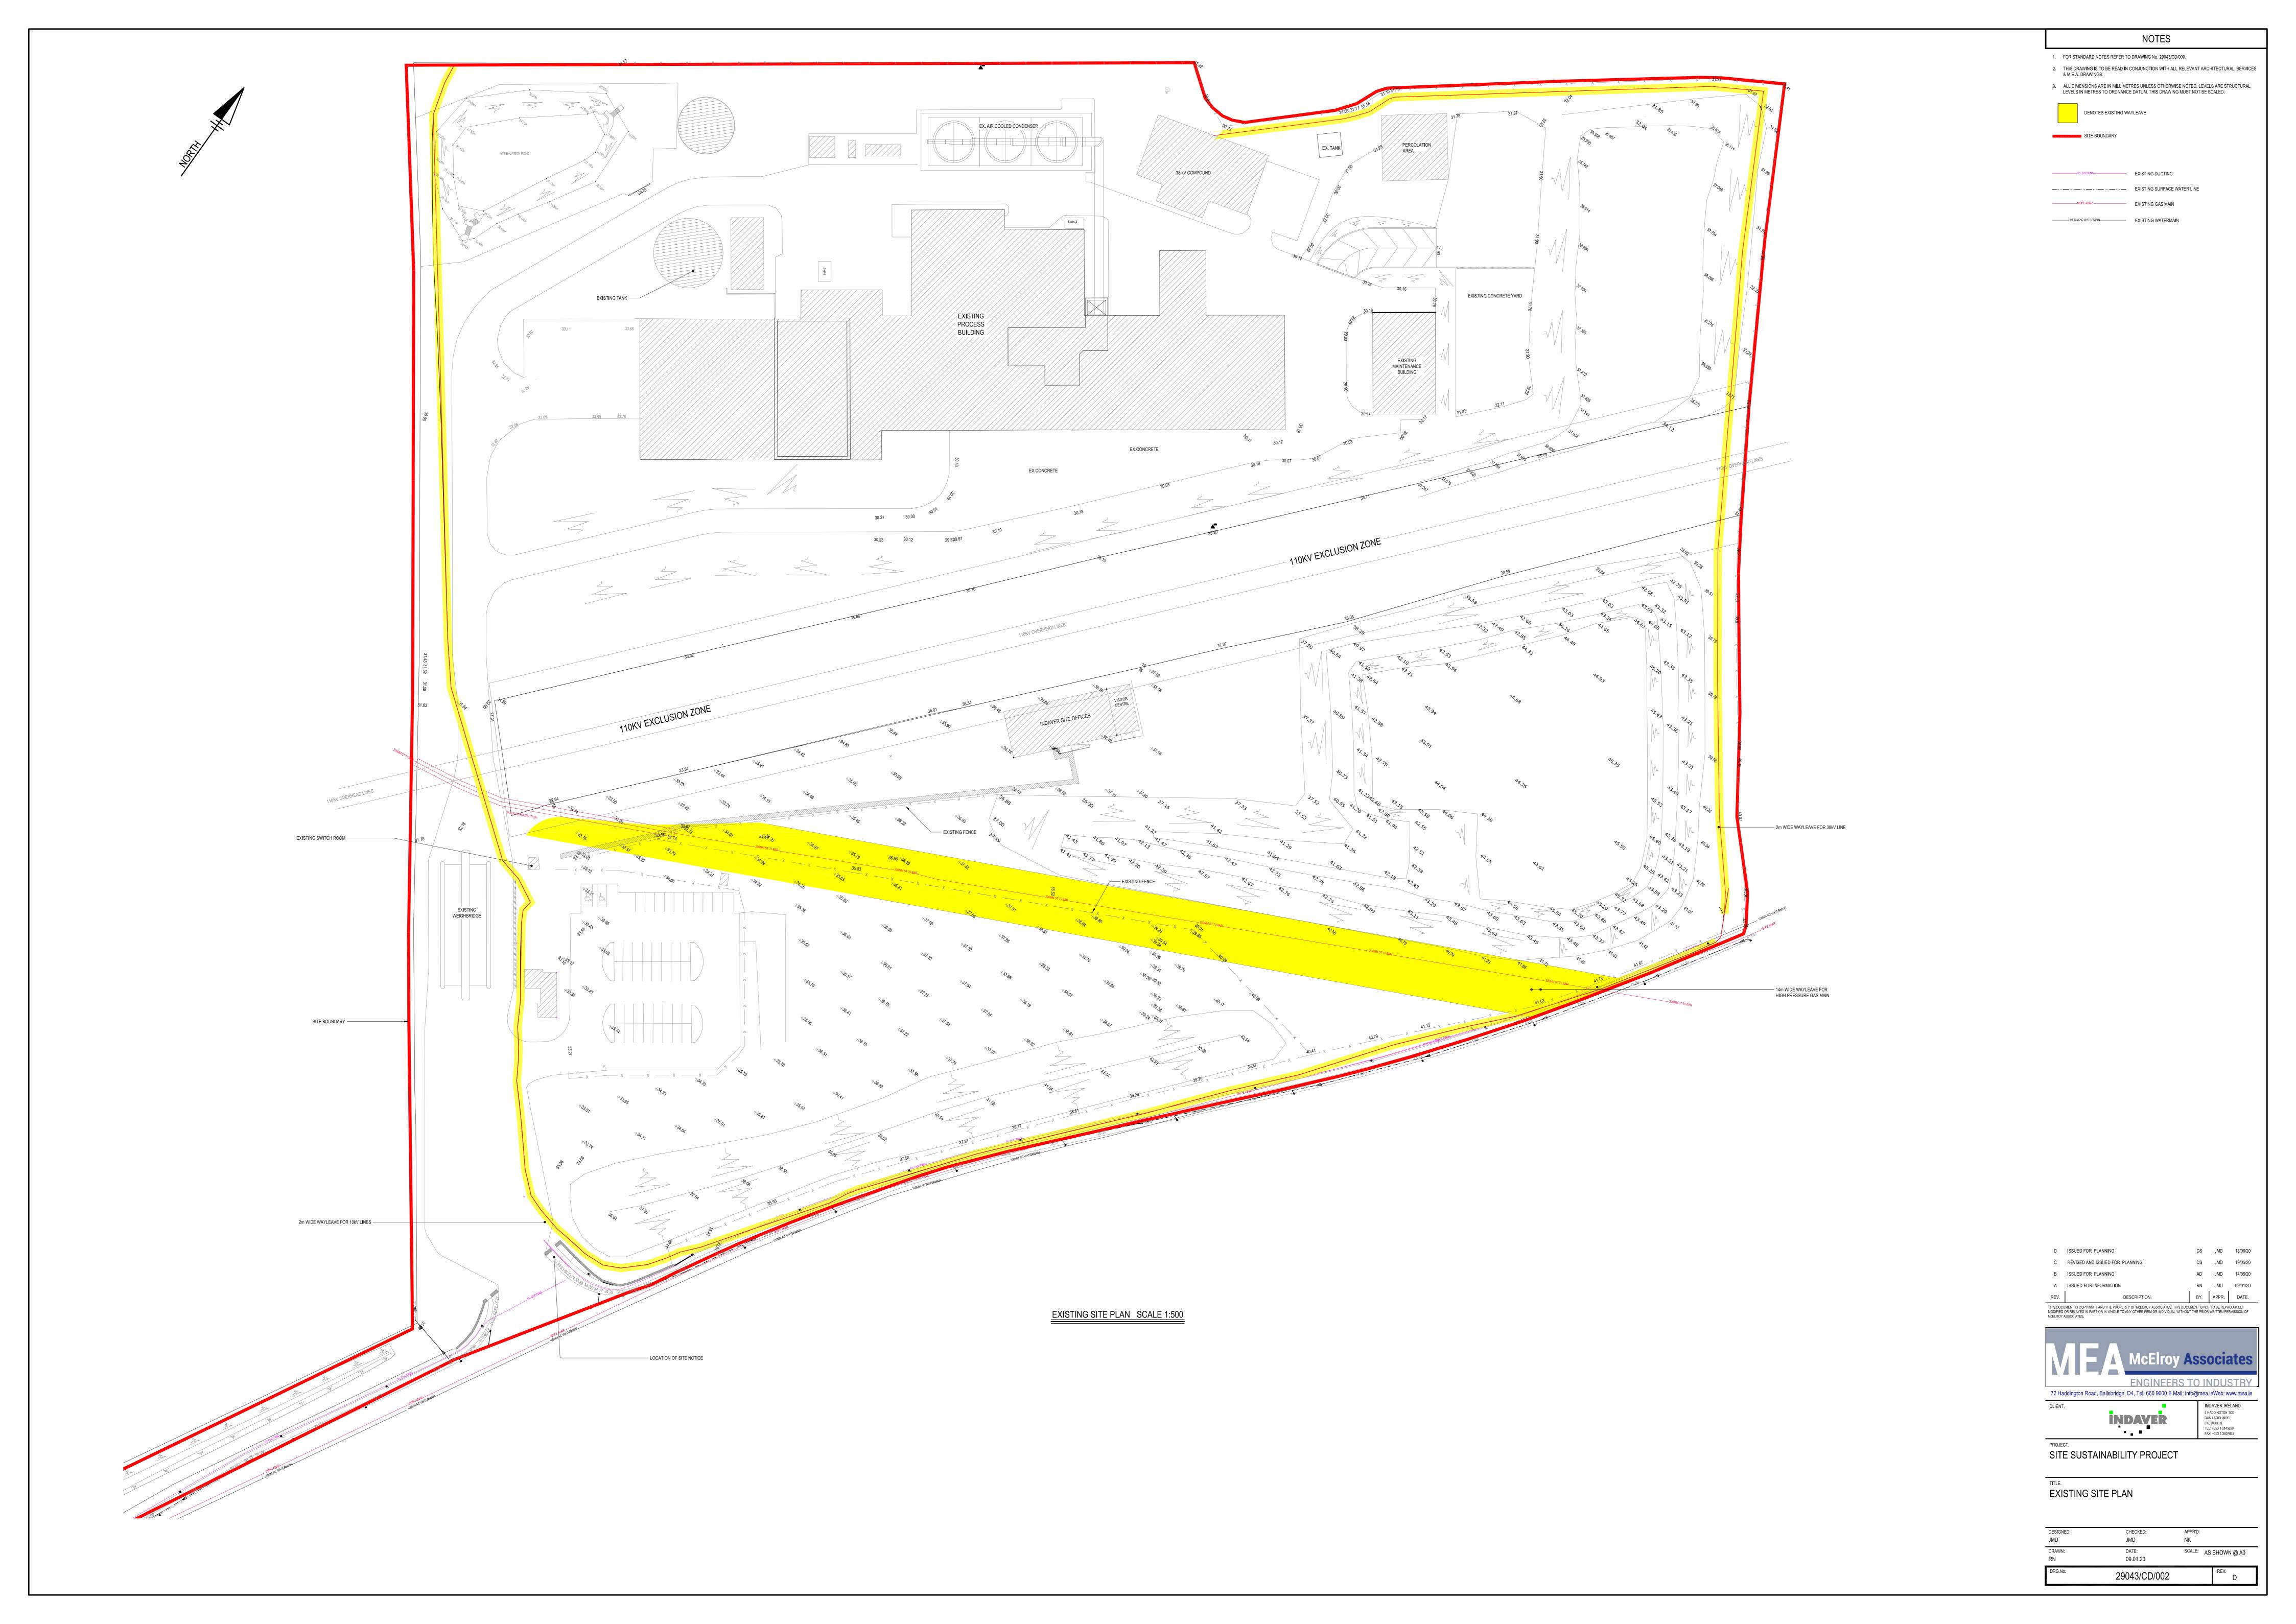
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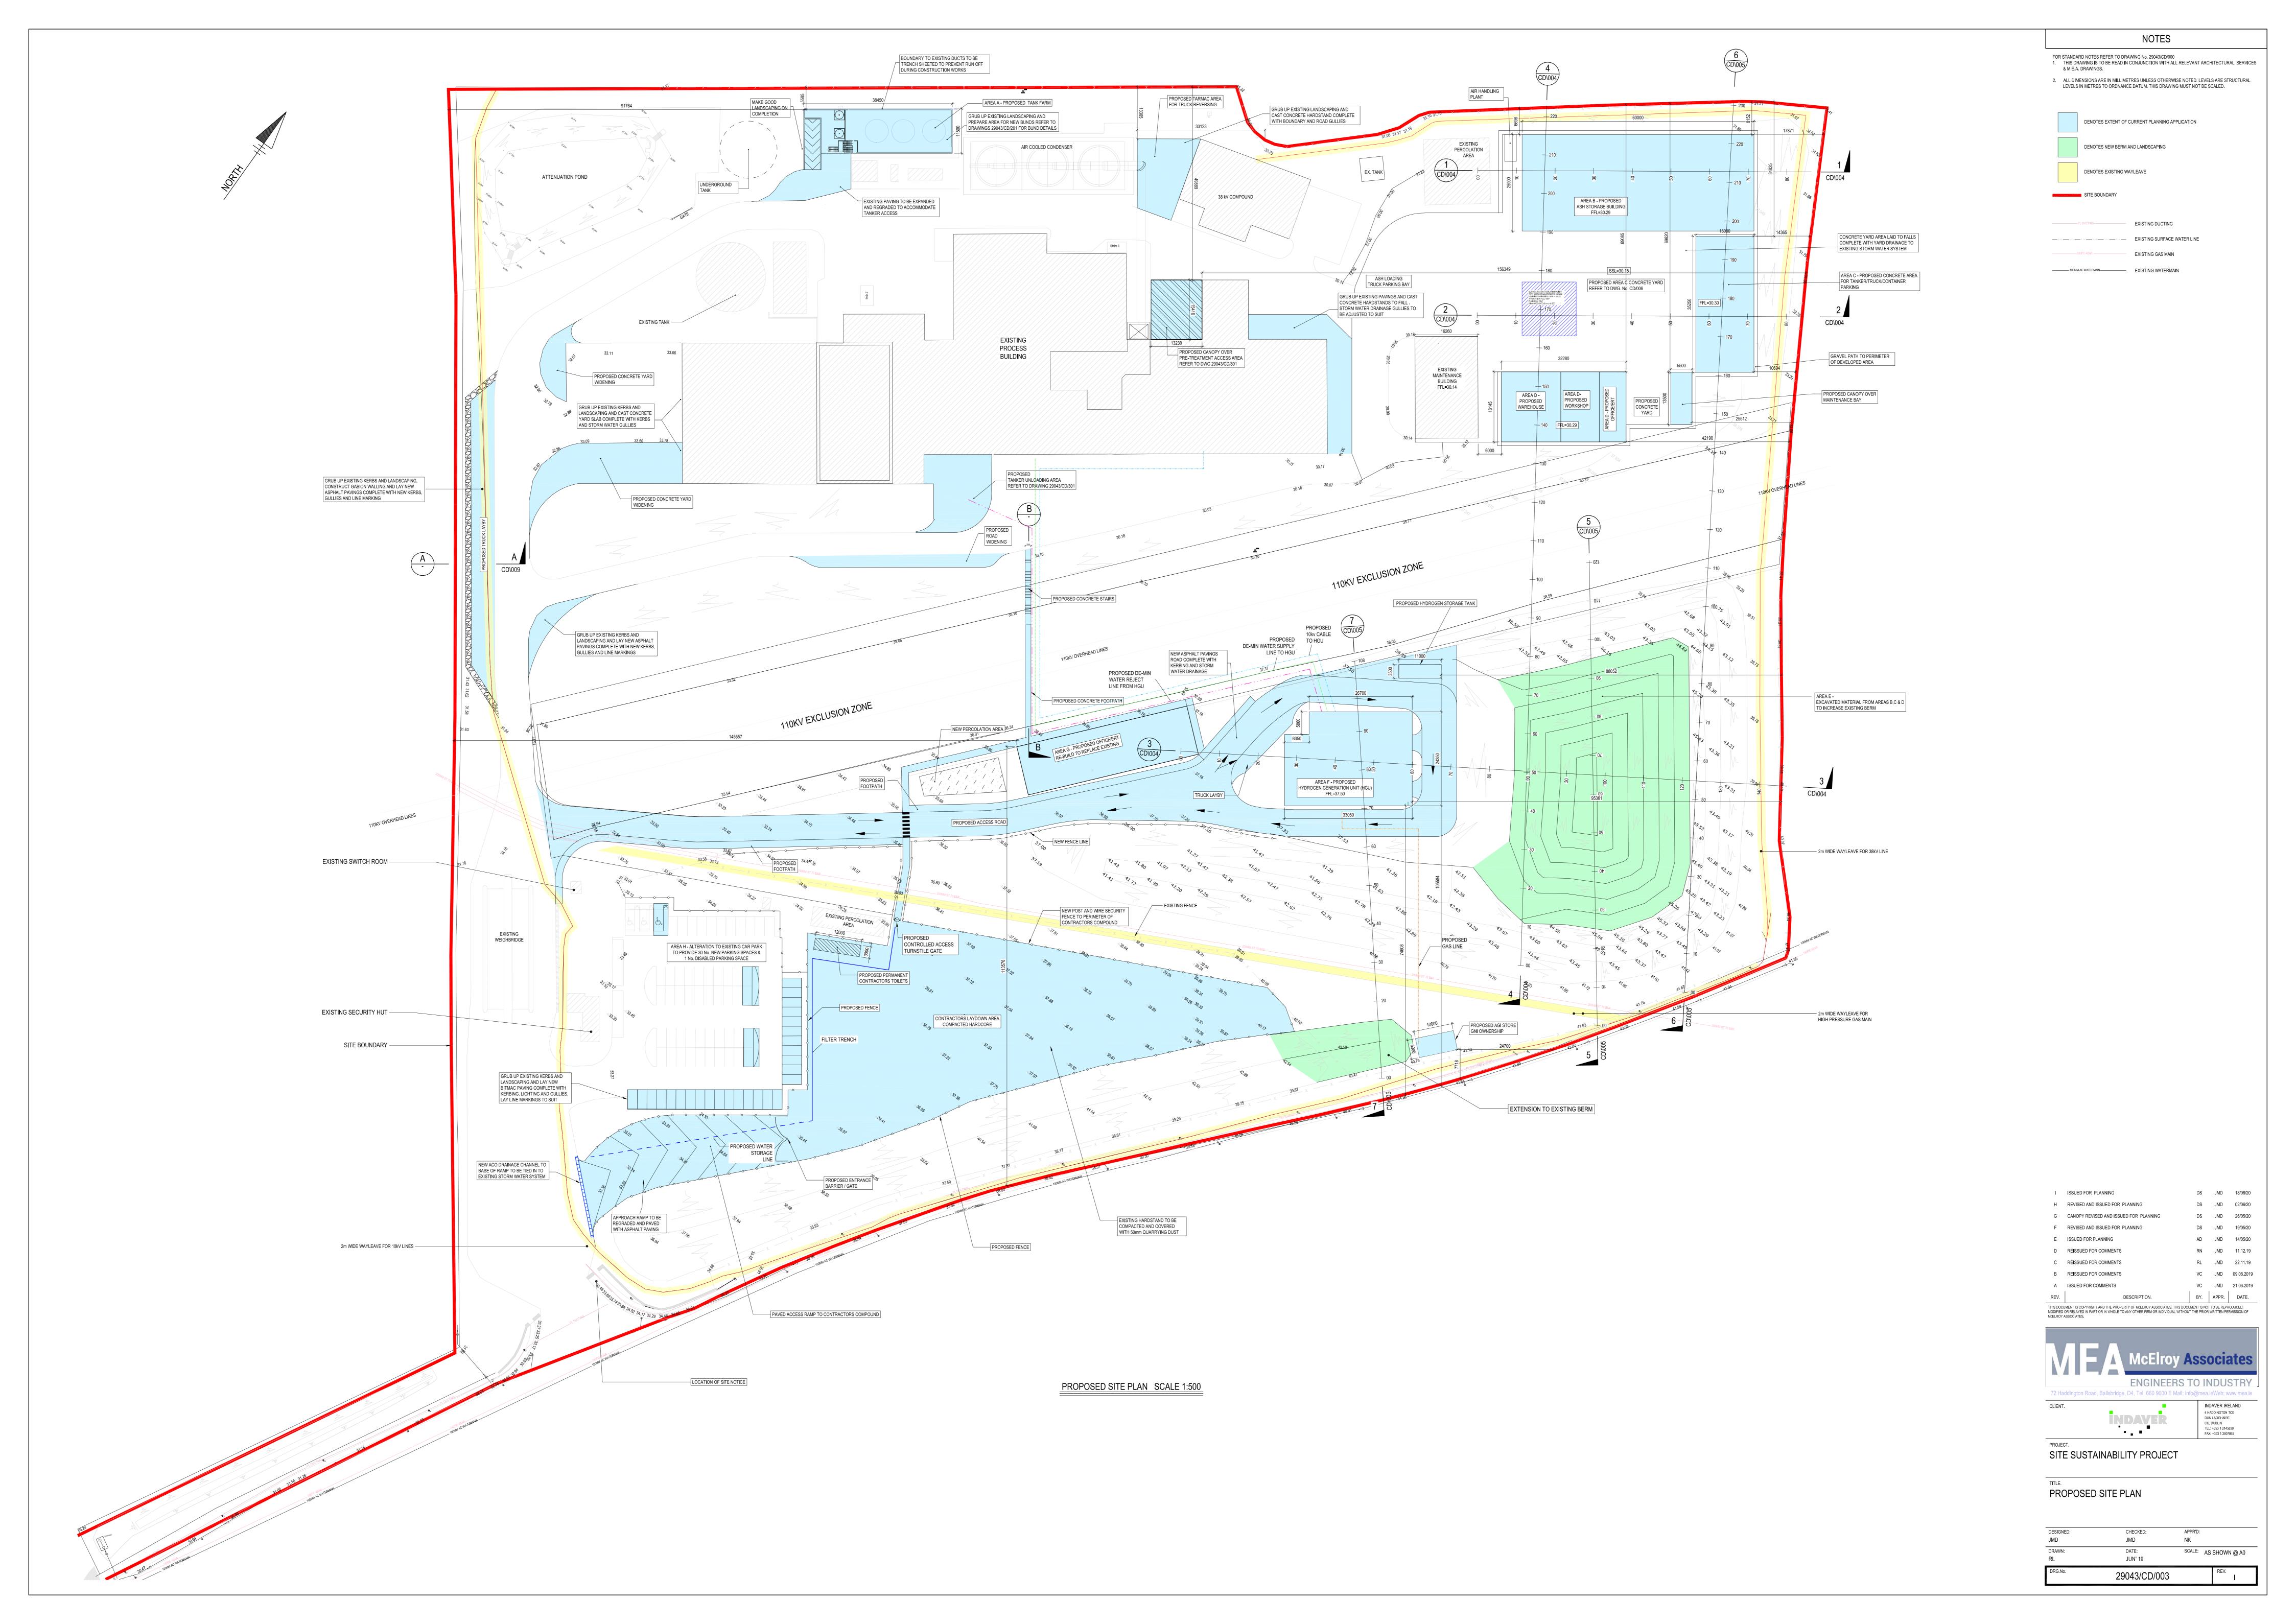
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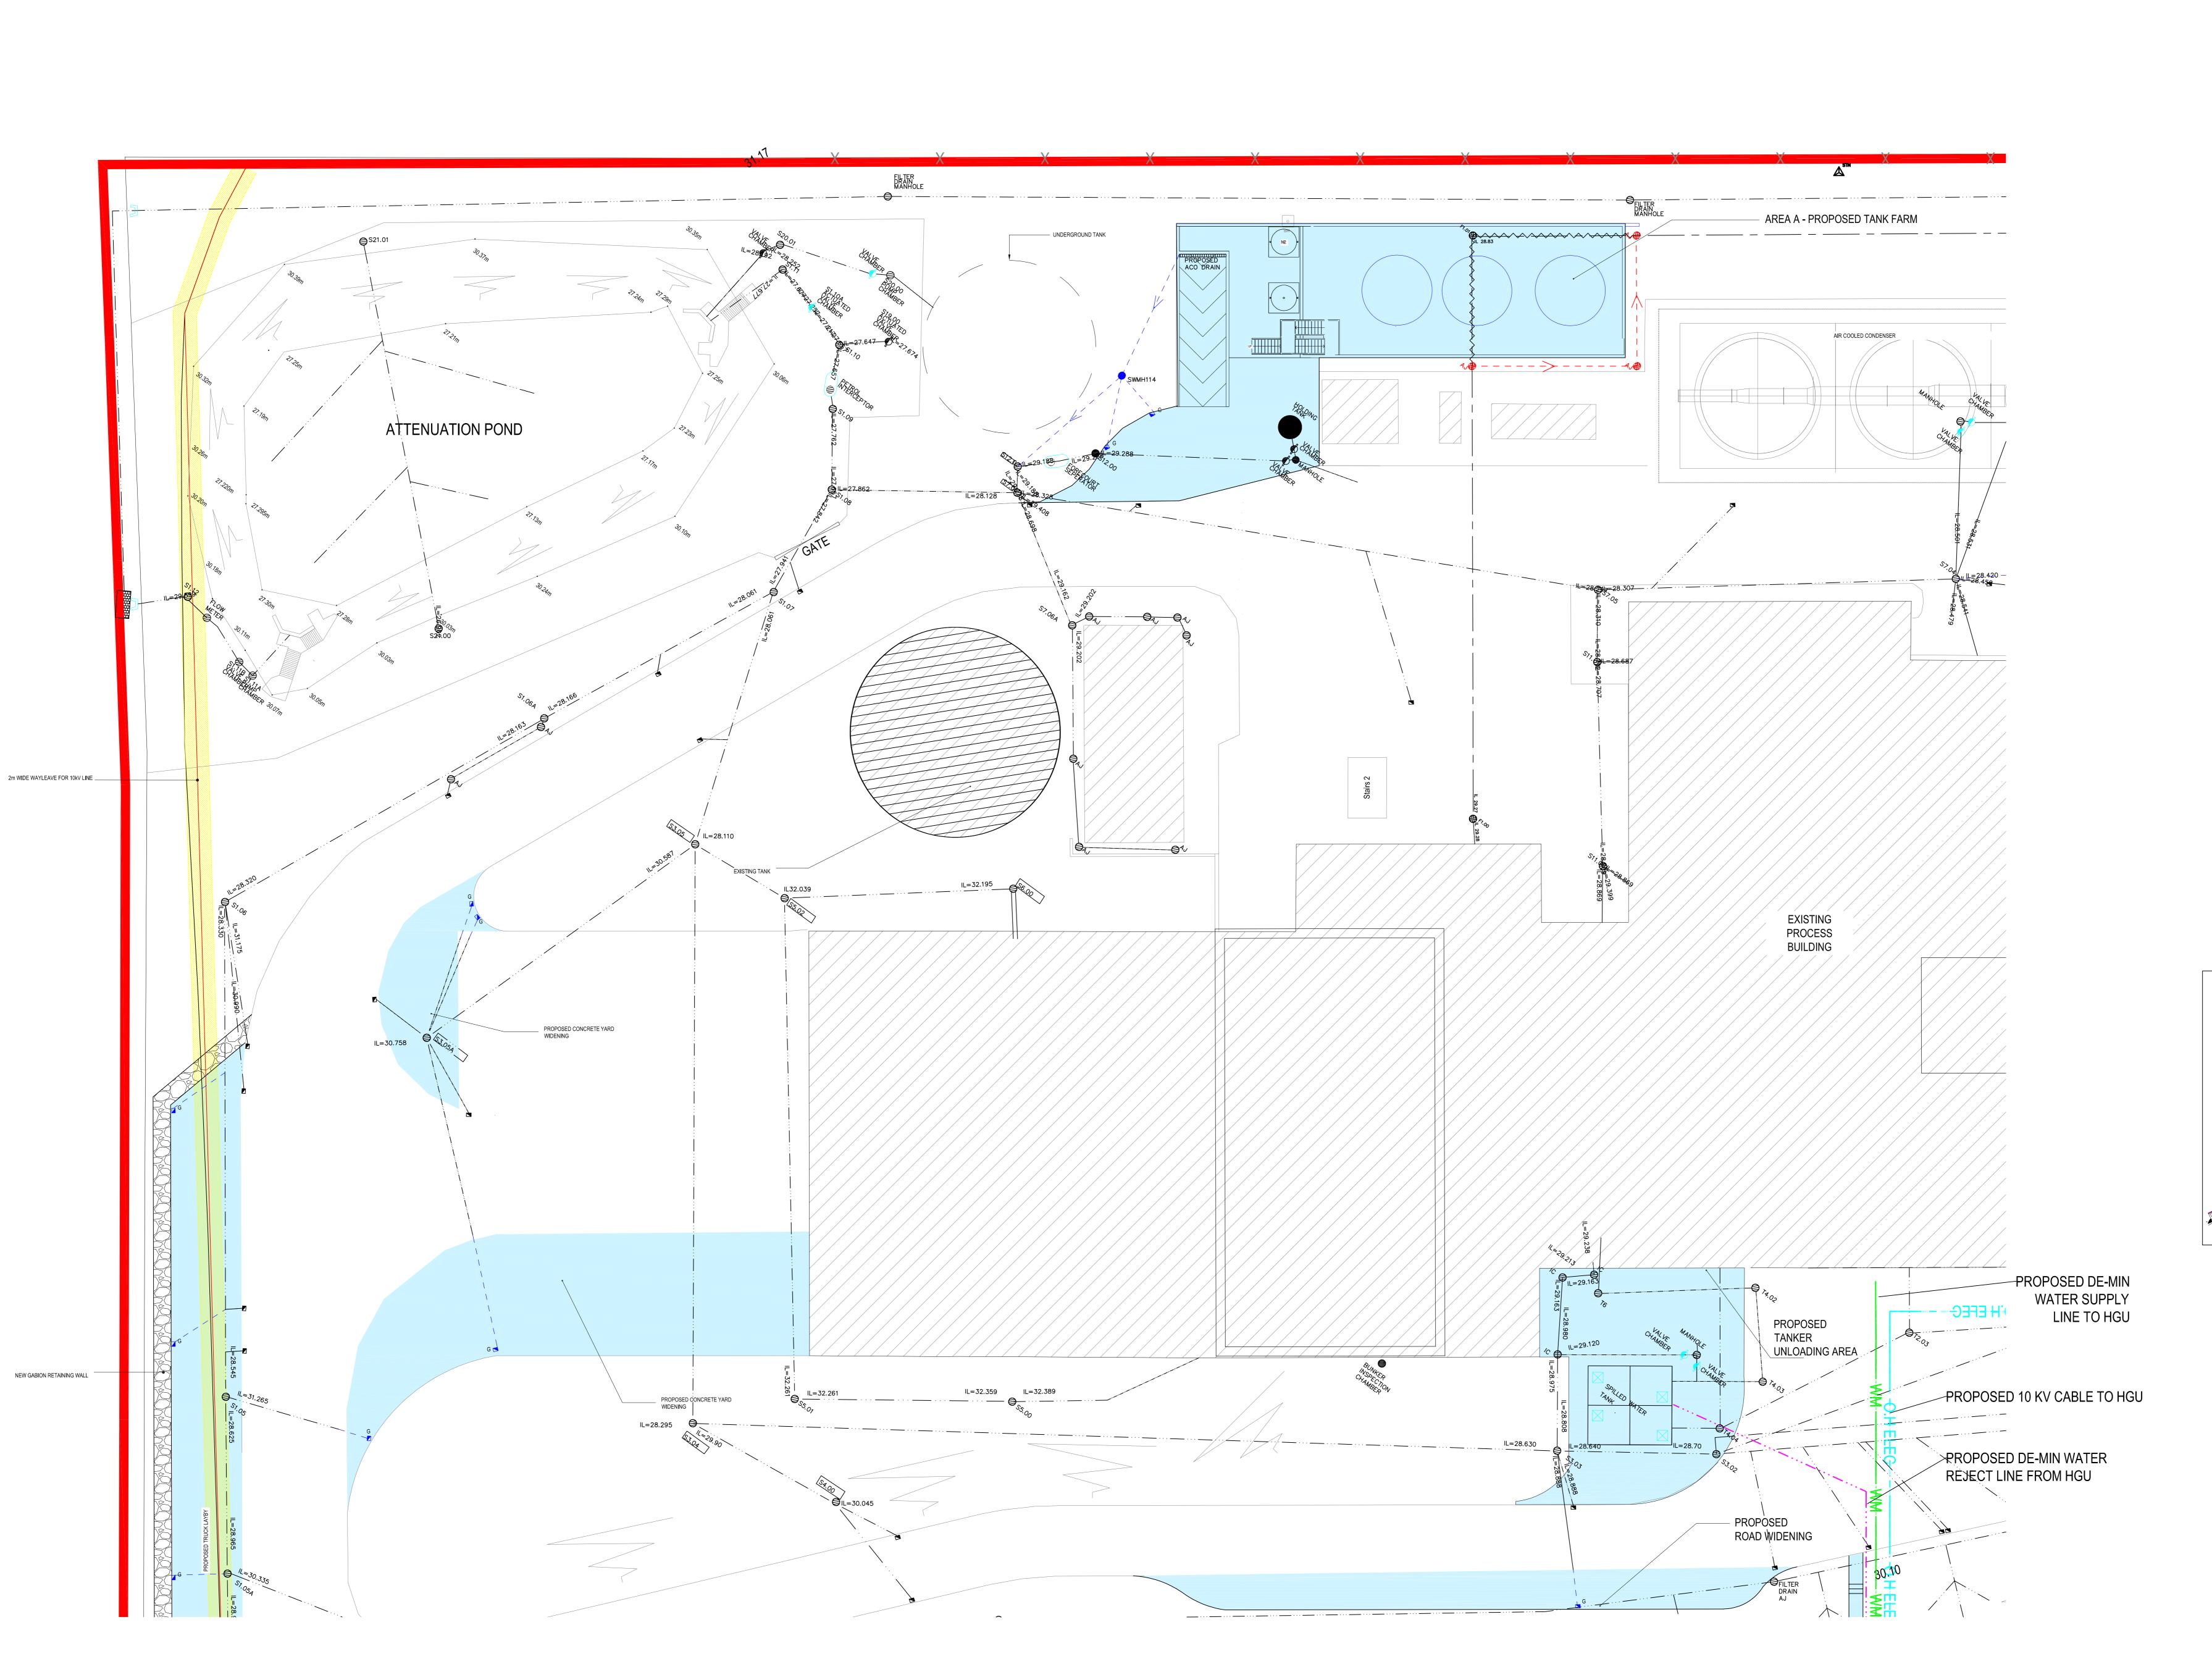
SITE LOCATION MAP

DESIGNED: CHECKED: JMD SCALE: AS SHOWN @ A1 JUN' 20 29043/CD/000











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DENOTES EXISTING WAYLEAVE

SITE BOUNDARY

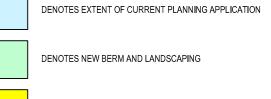

WM PROPOSED DE-MIN WATER SUPPLY LINE TO HGU

PROPOSED DE-MIN WATER REJECT LINE FROM HGU

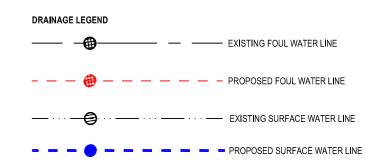GAS GAS PROPOSED NEW GAS LINE FROM HGU

O.H ELEC PROPOSED 10 KV CABLE TO HGU

Foul Sewer Notes: 1. The location of all existing services shall be Confirmed prior to any

- Proposed foul water drainage pipework shall be Wavin uPVC pipework and fittings.
- pipework and fittings.

 3. Proposed foul water drainage designed to achieve a minimum self-cleansing velocity of 0.75m/s.
- All manhole covers shall be ductile iron solid top covers load class D400 to IS EN 124.
- Access Junctions shall be Wavin 160mmØ AJ with B125 ductile iron cover and shall be located in pedestrian areas only.


Surface Water Drain Notes:


- Proposed surface water drainage designed to achieve a minimum self-cleansing velocity of 1.0m/s.
- 2. Proposed drainage pipework shall be JFC Twin Corripipe pipework and fittings.
- The flow control device shall be a Hydrobrake Optimum vortex flow control by HRD

3. All manhole covers shall be ductile iron solid top covers load class D400 to IS EN

- Design flow = 4L/Sec for 30yr return period storm
 Design head = 2.0m
- All drainage channels in paved areas shall be ACO drainage channel and grating local class D400 with sump unit and silt bucket unless noted otherwise. The contractor shall include for endcaps at the head of each channel.
 PD100F 30.1 Type 2
- Road gullies to be located to drain a maximum area of 200m². Grating shall be sized to achieve a minimum wet area of 745cm².
- PROPOSED SURFACE WATER MANHOLE SCHEDULE

 MANHOLE REE | INVERTLEVEL | COVER LEVEL

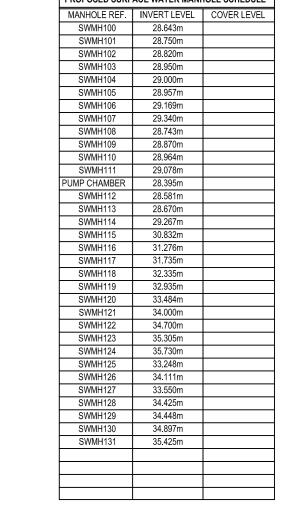

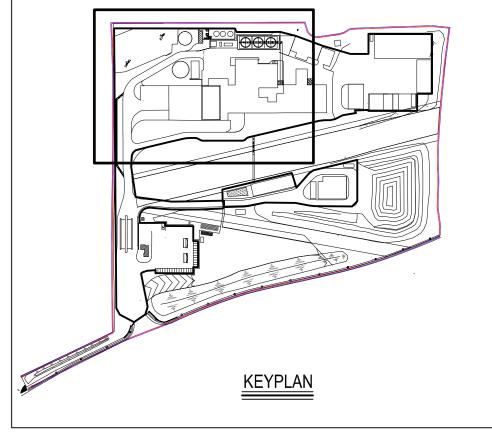

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 JMD
 18/06/20

 C
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 AD
 NK
 14/05/20

 B
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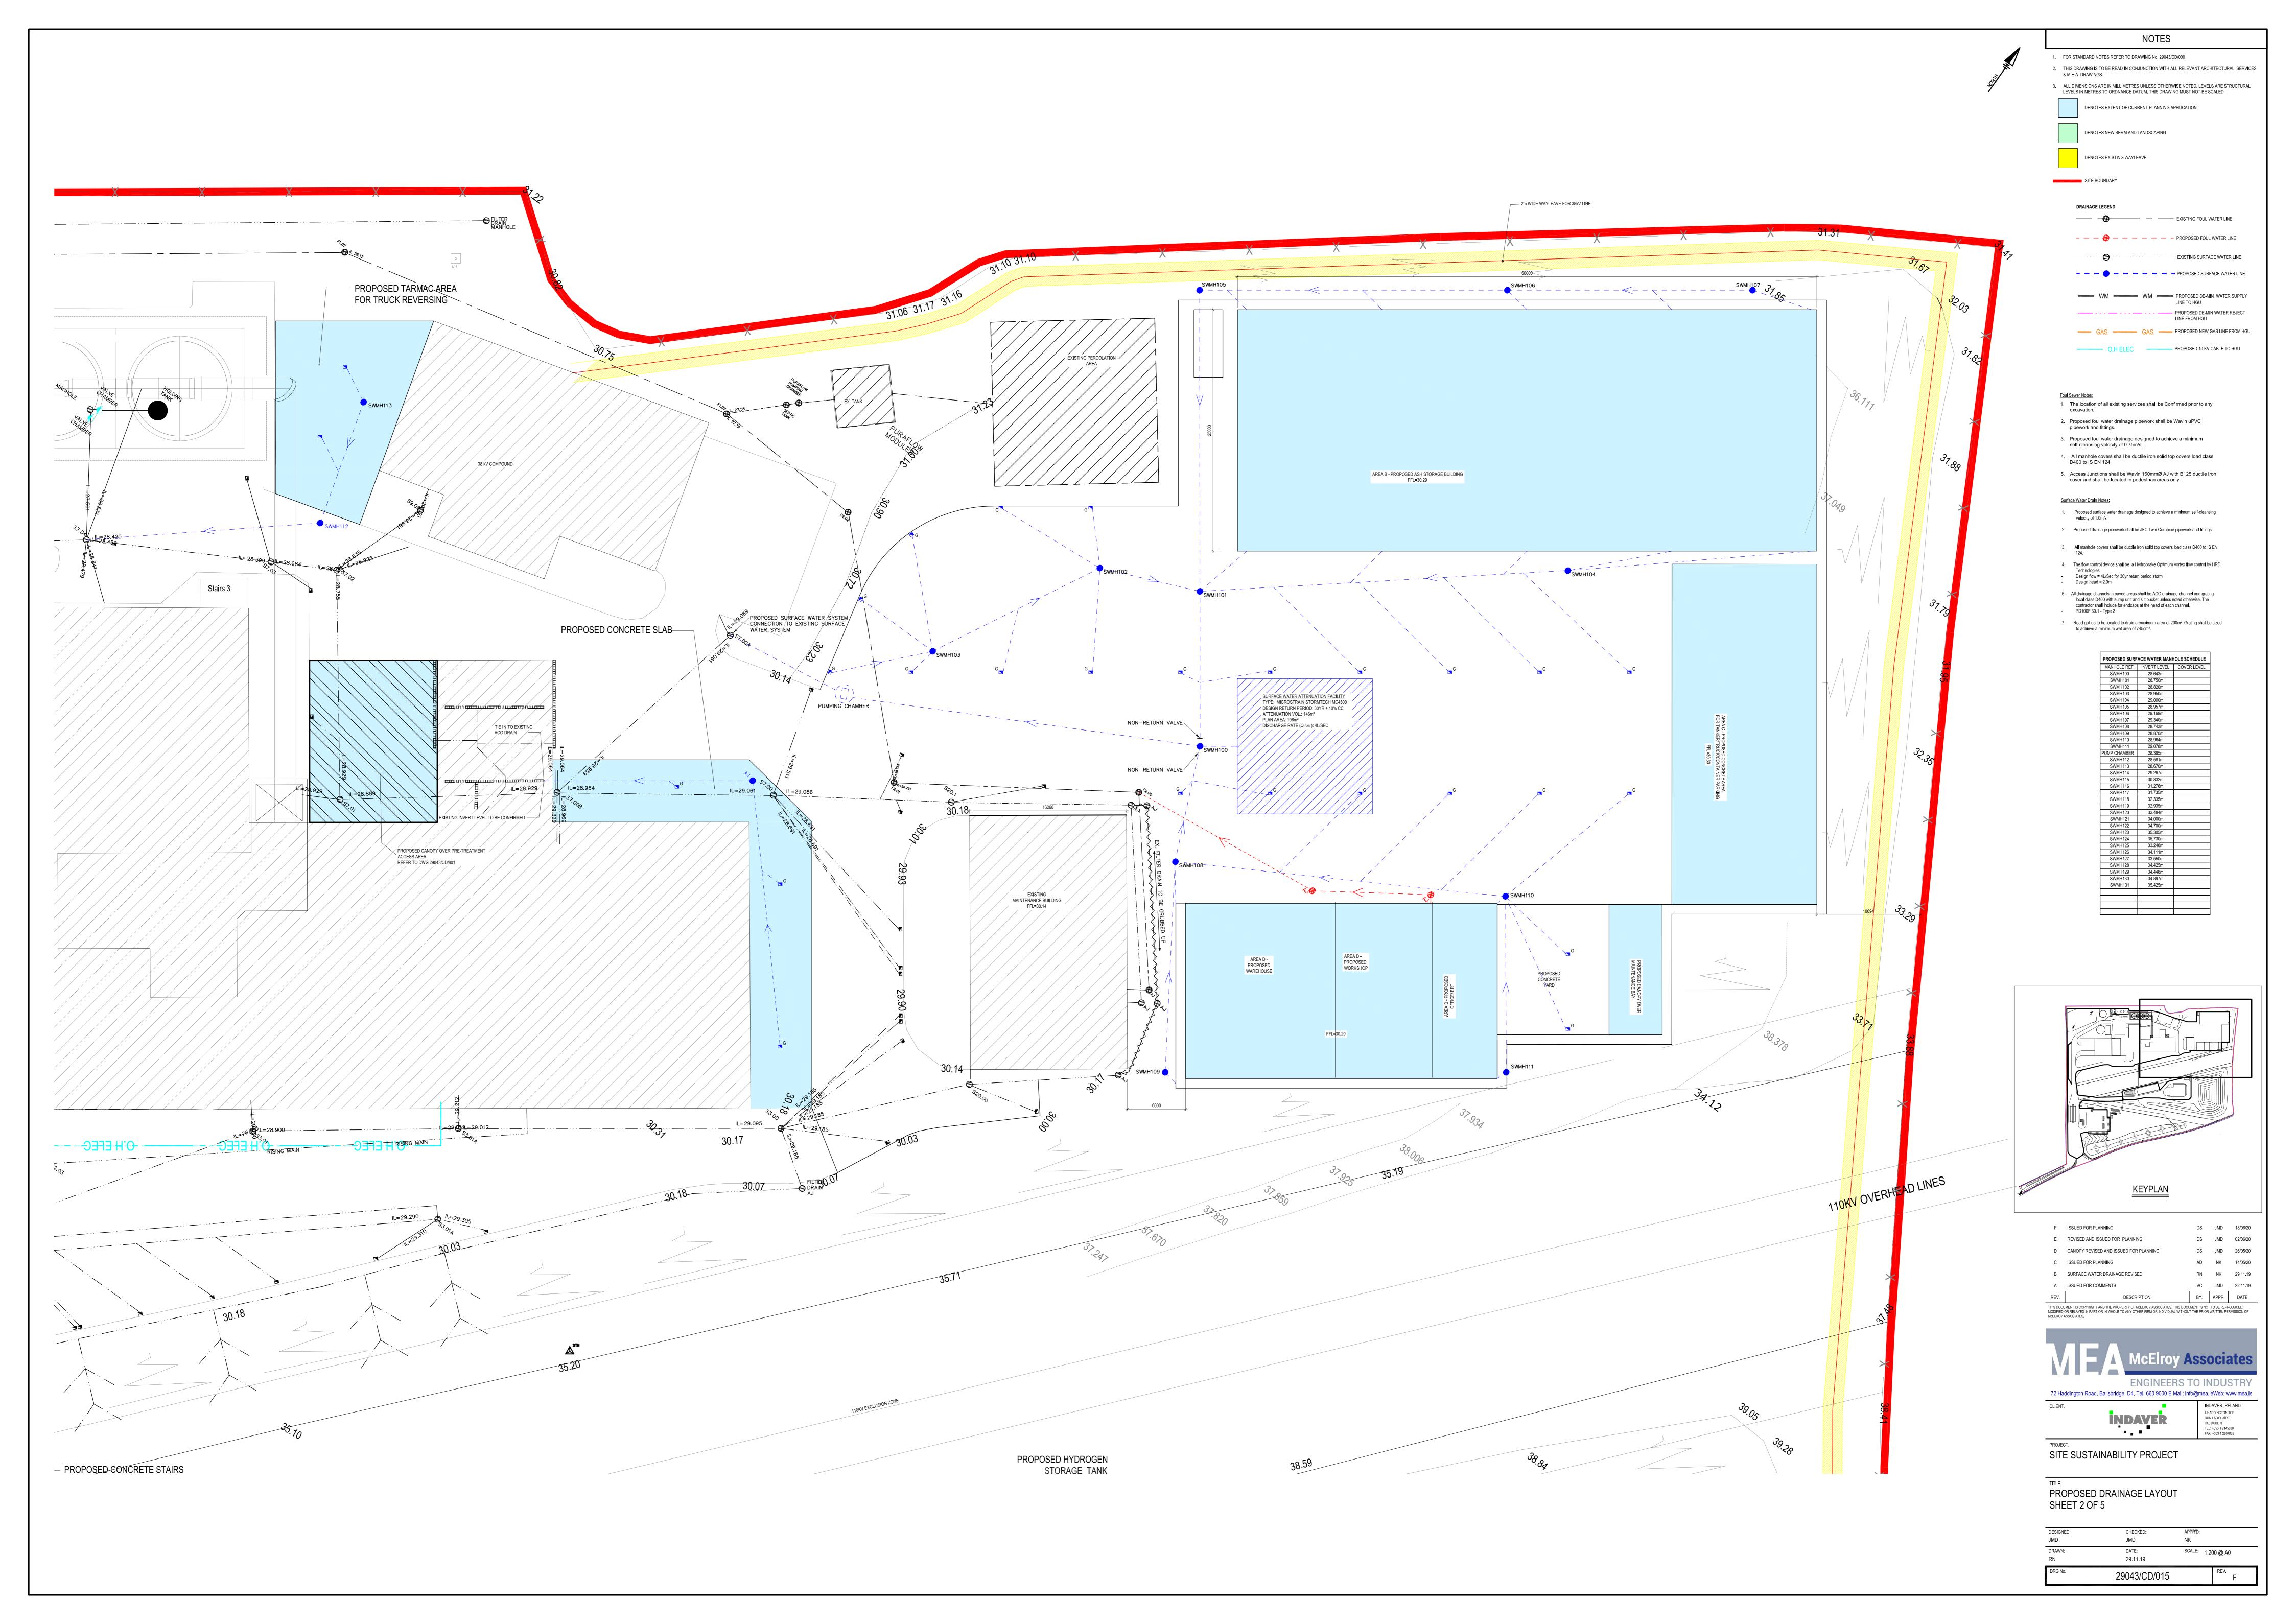
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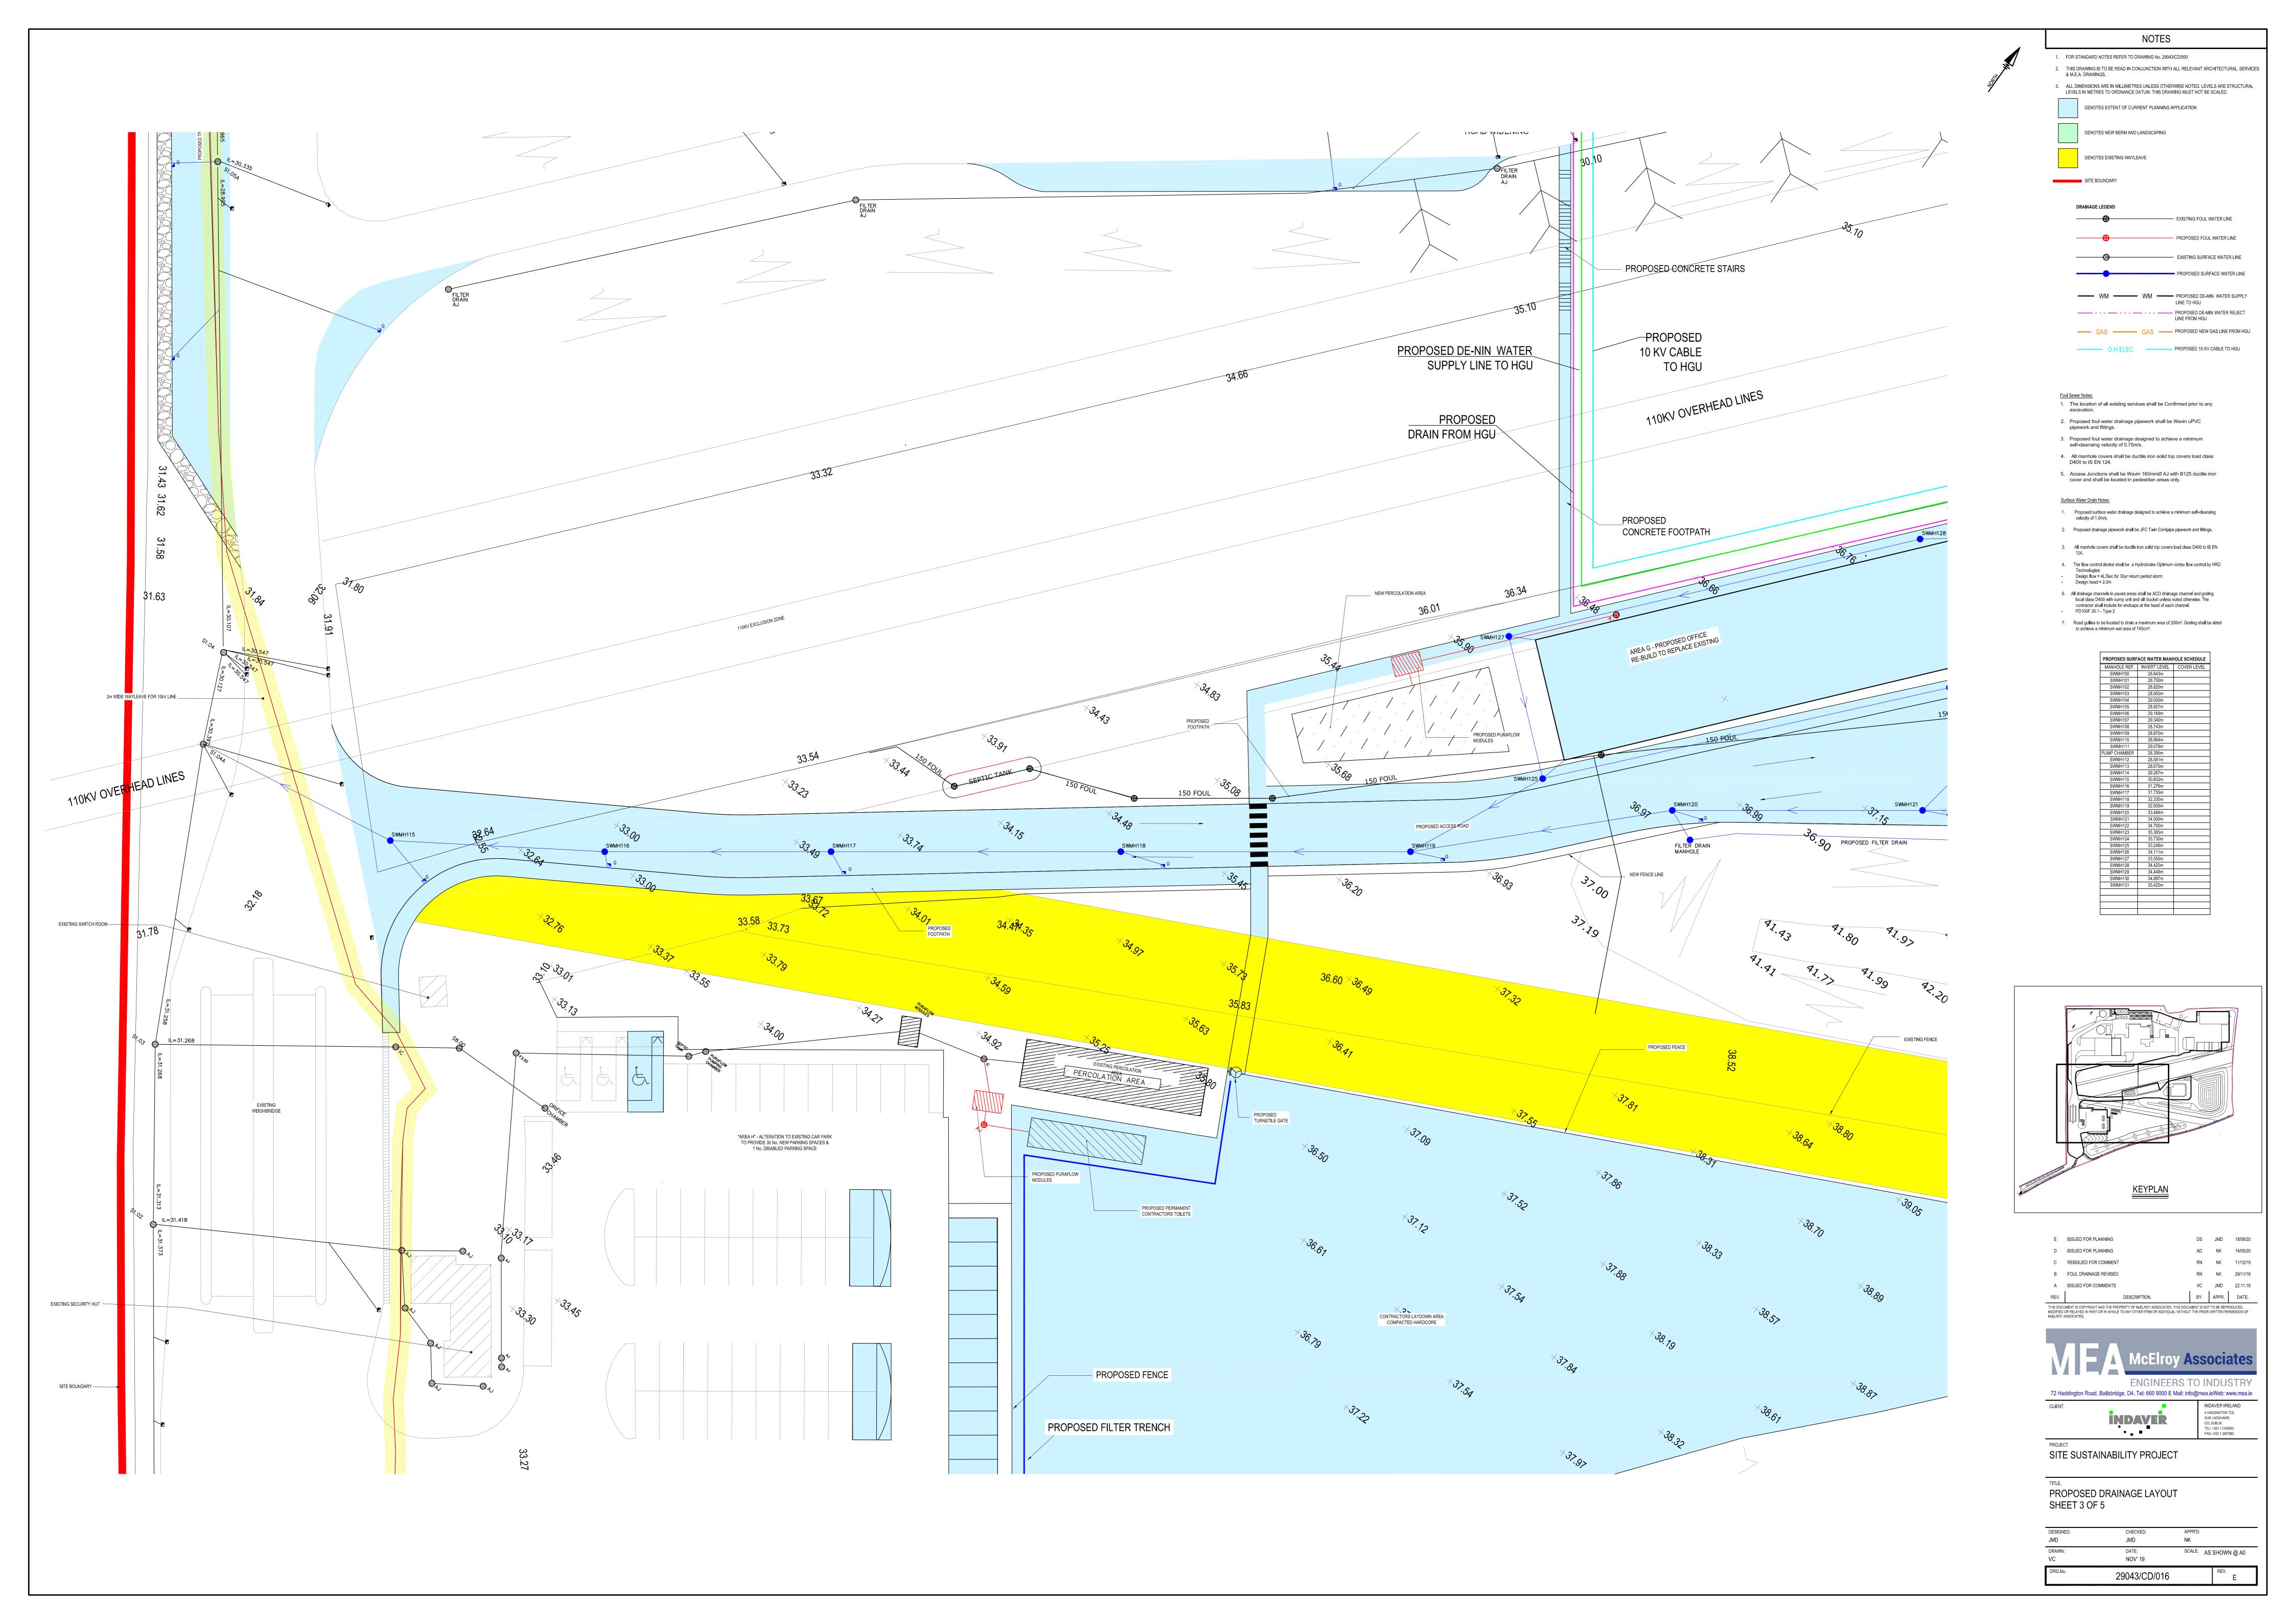
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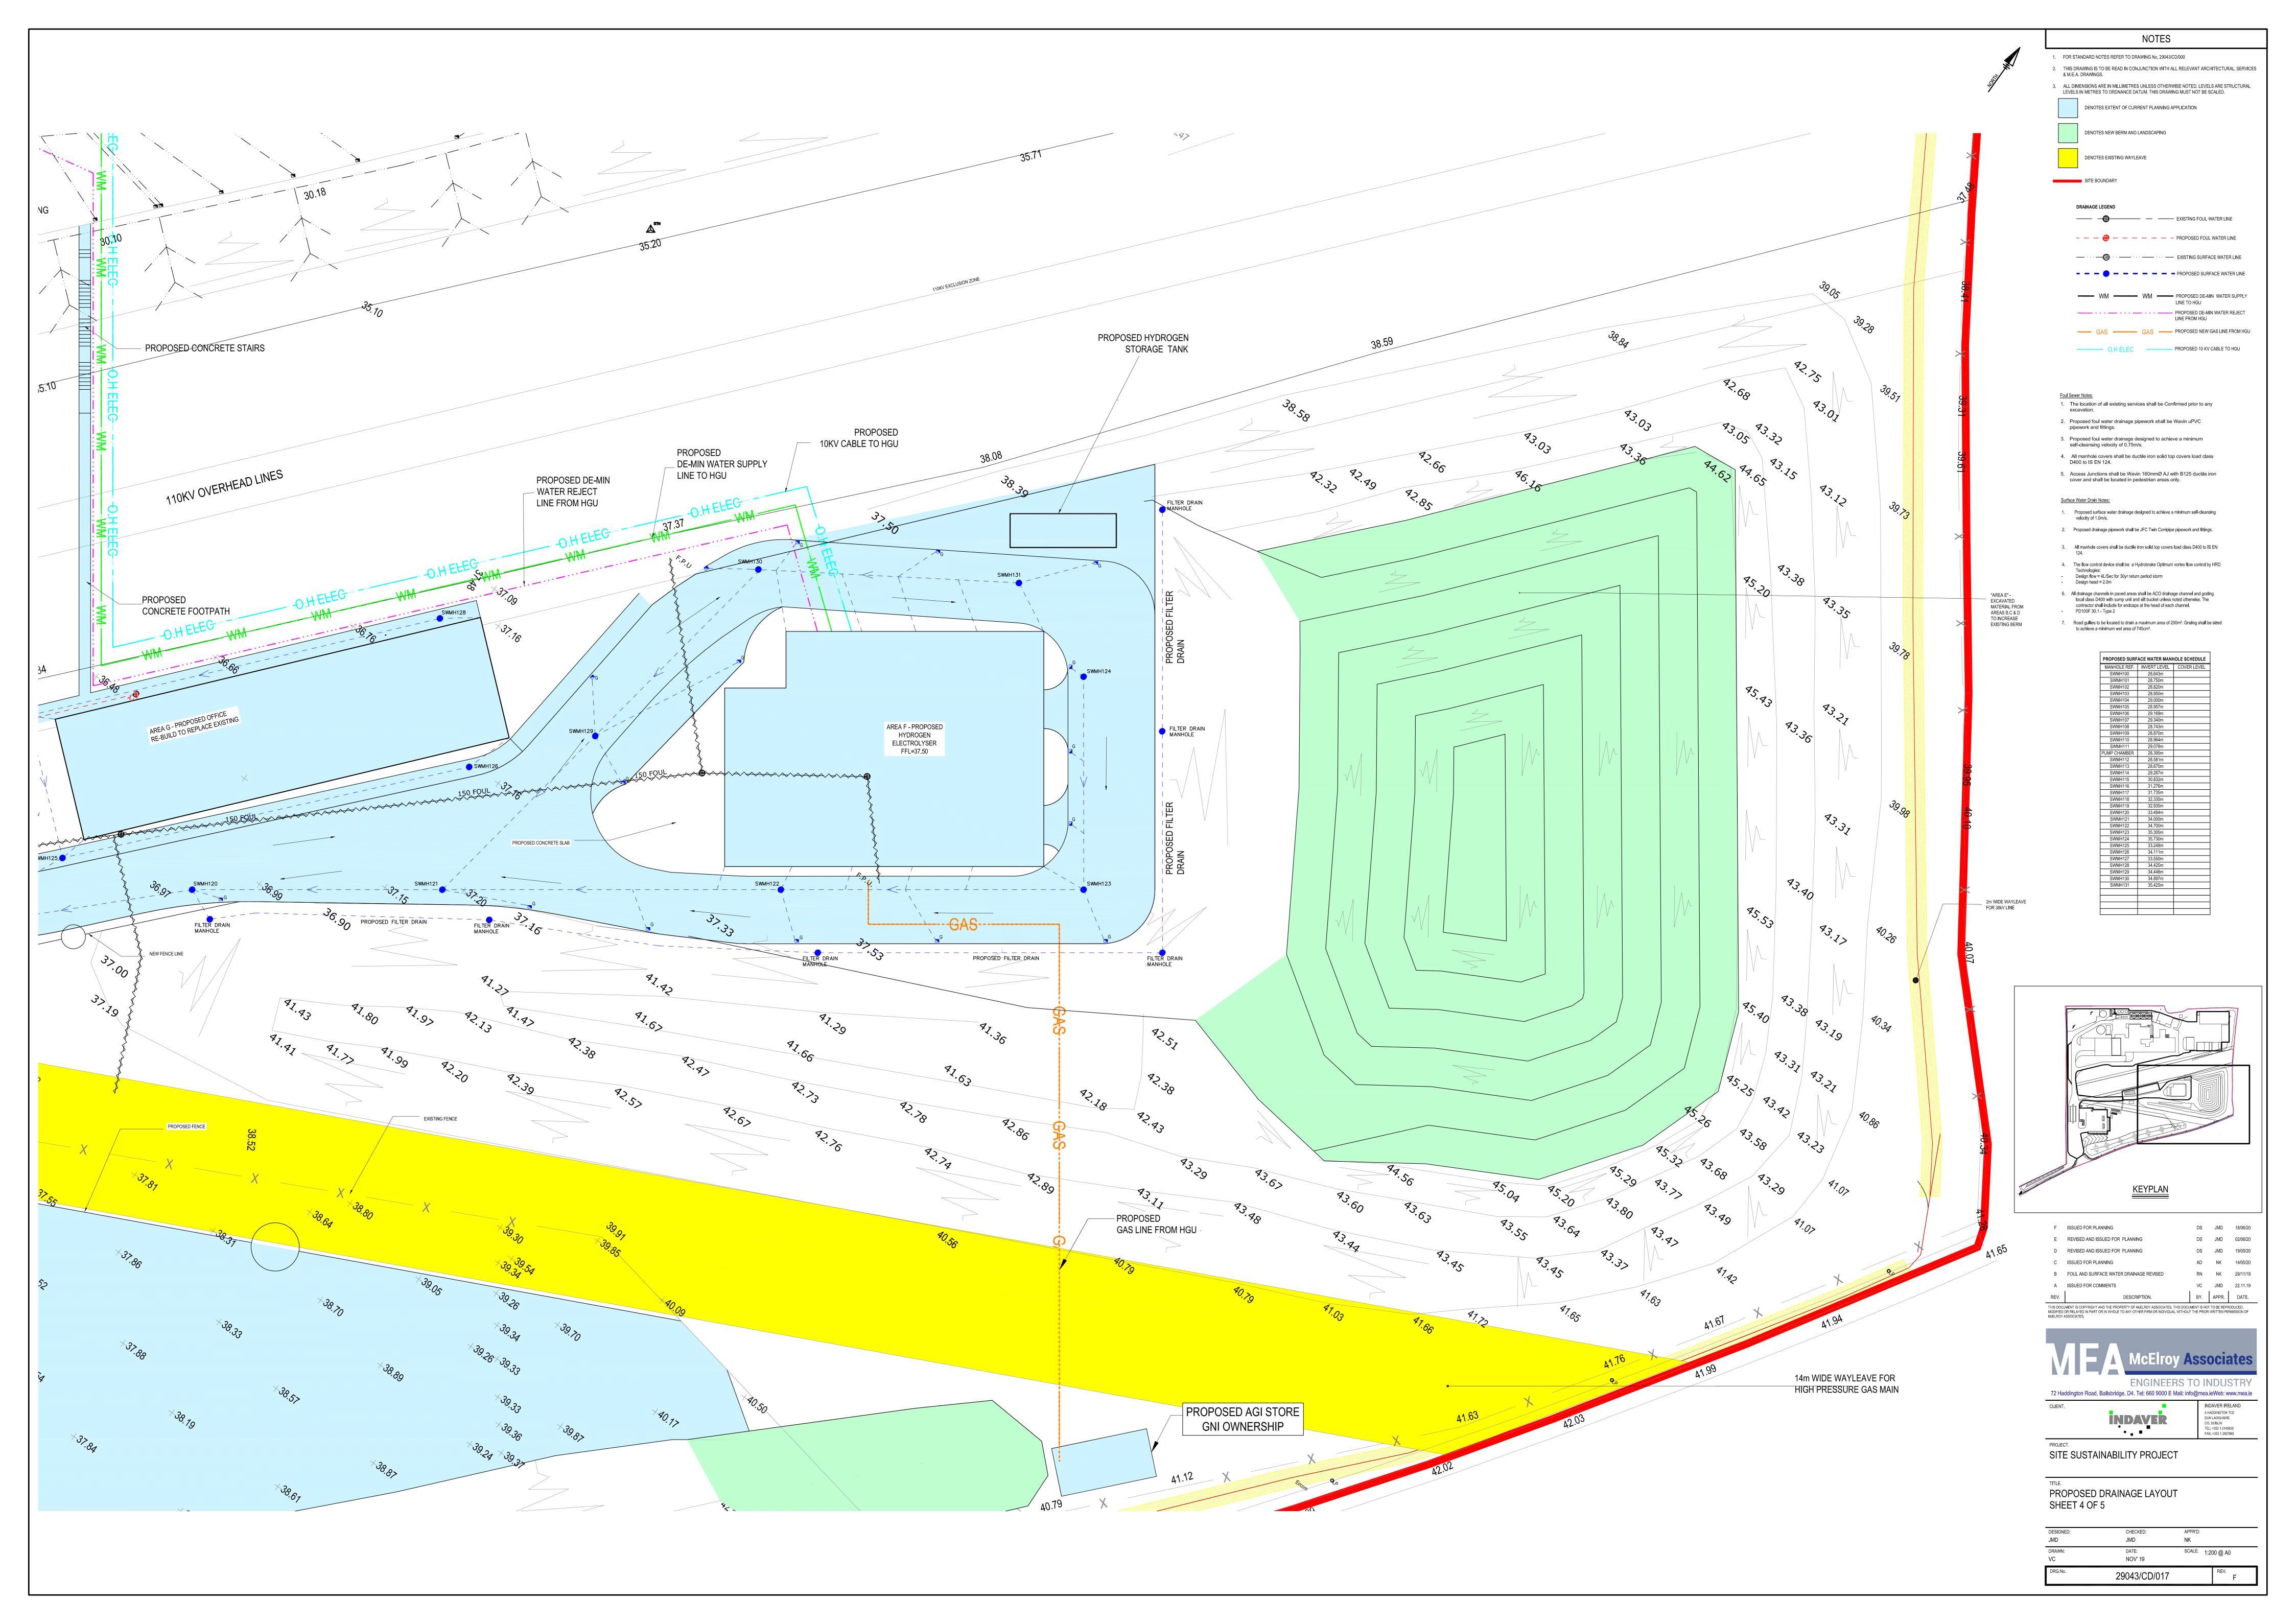
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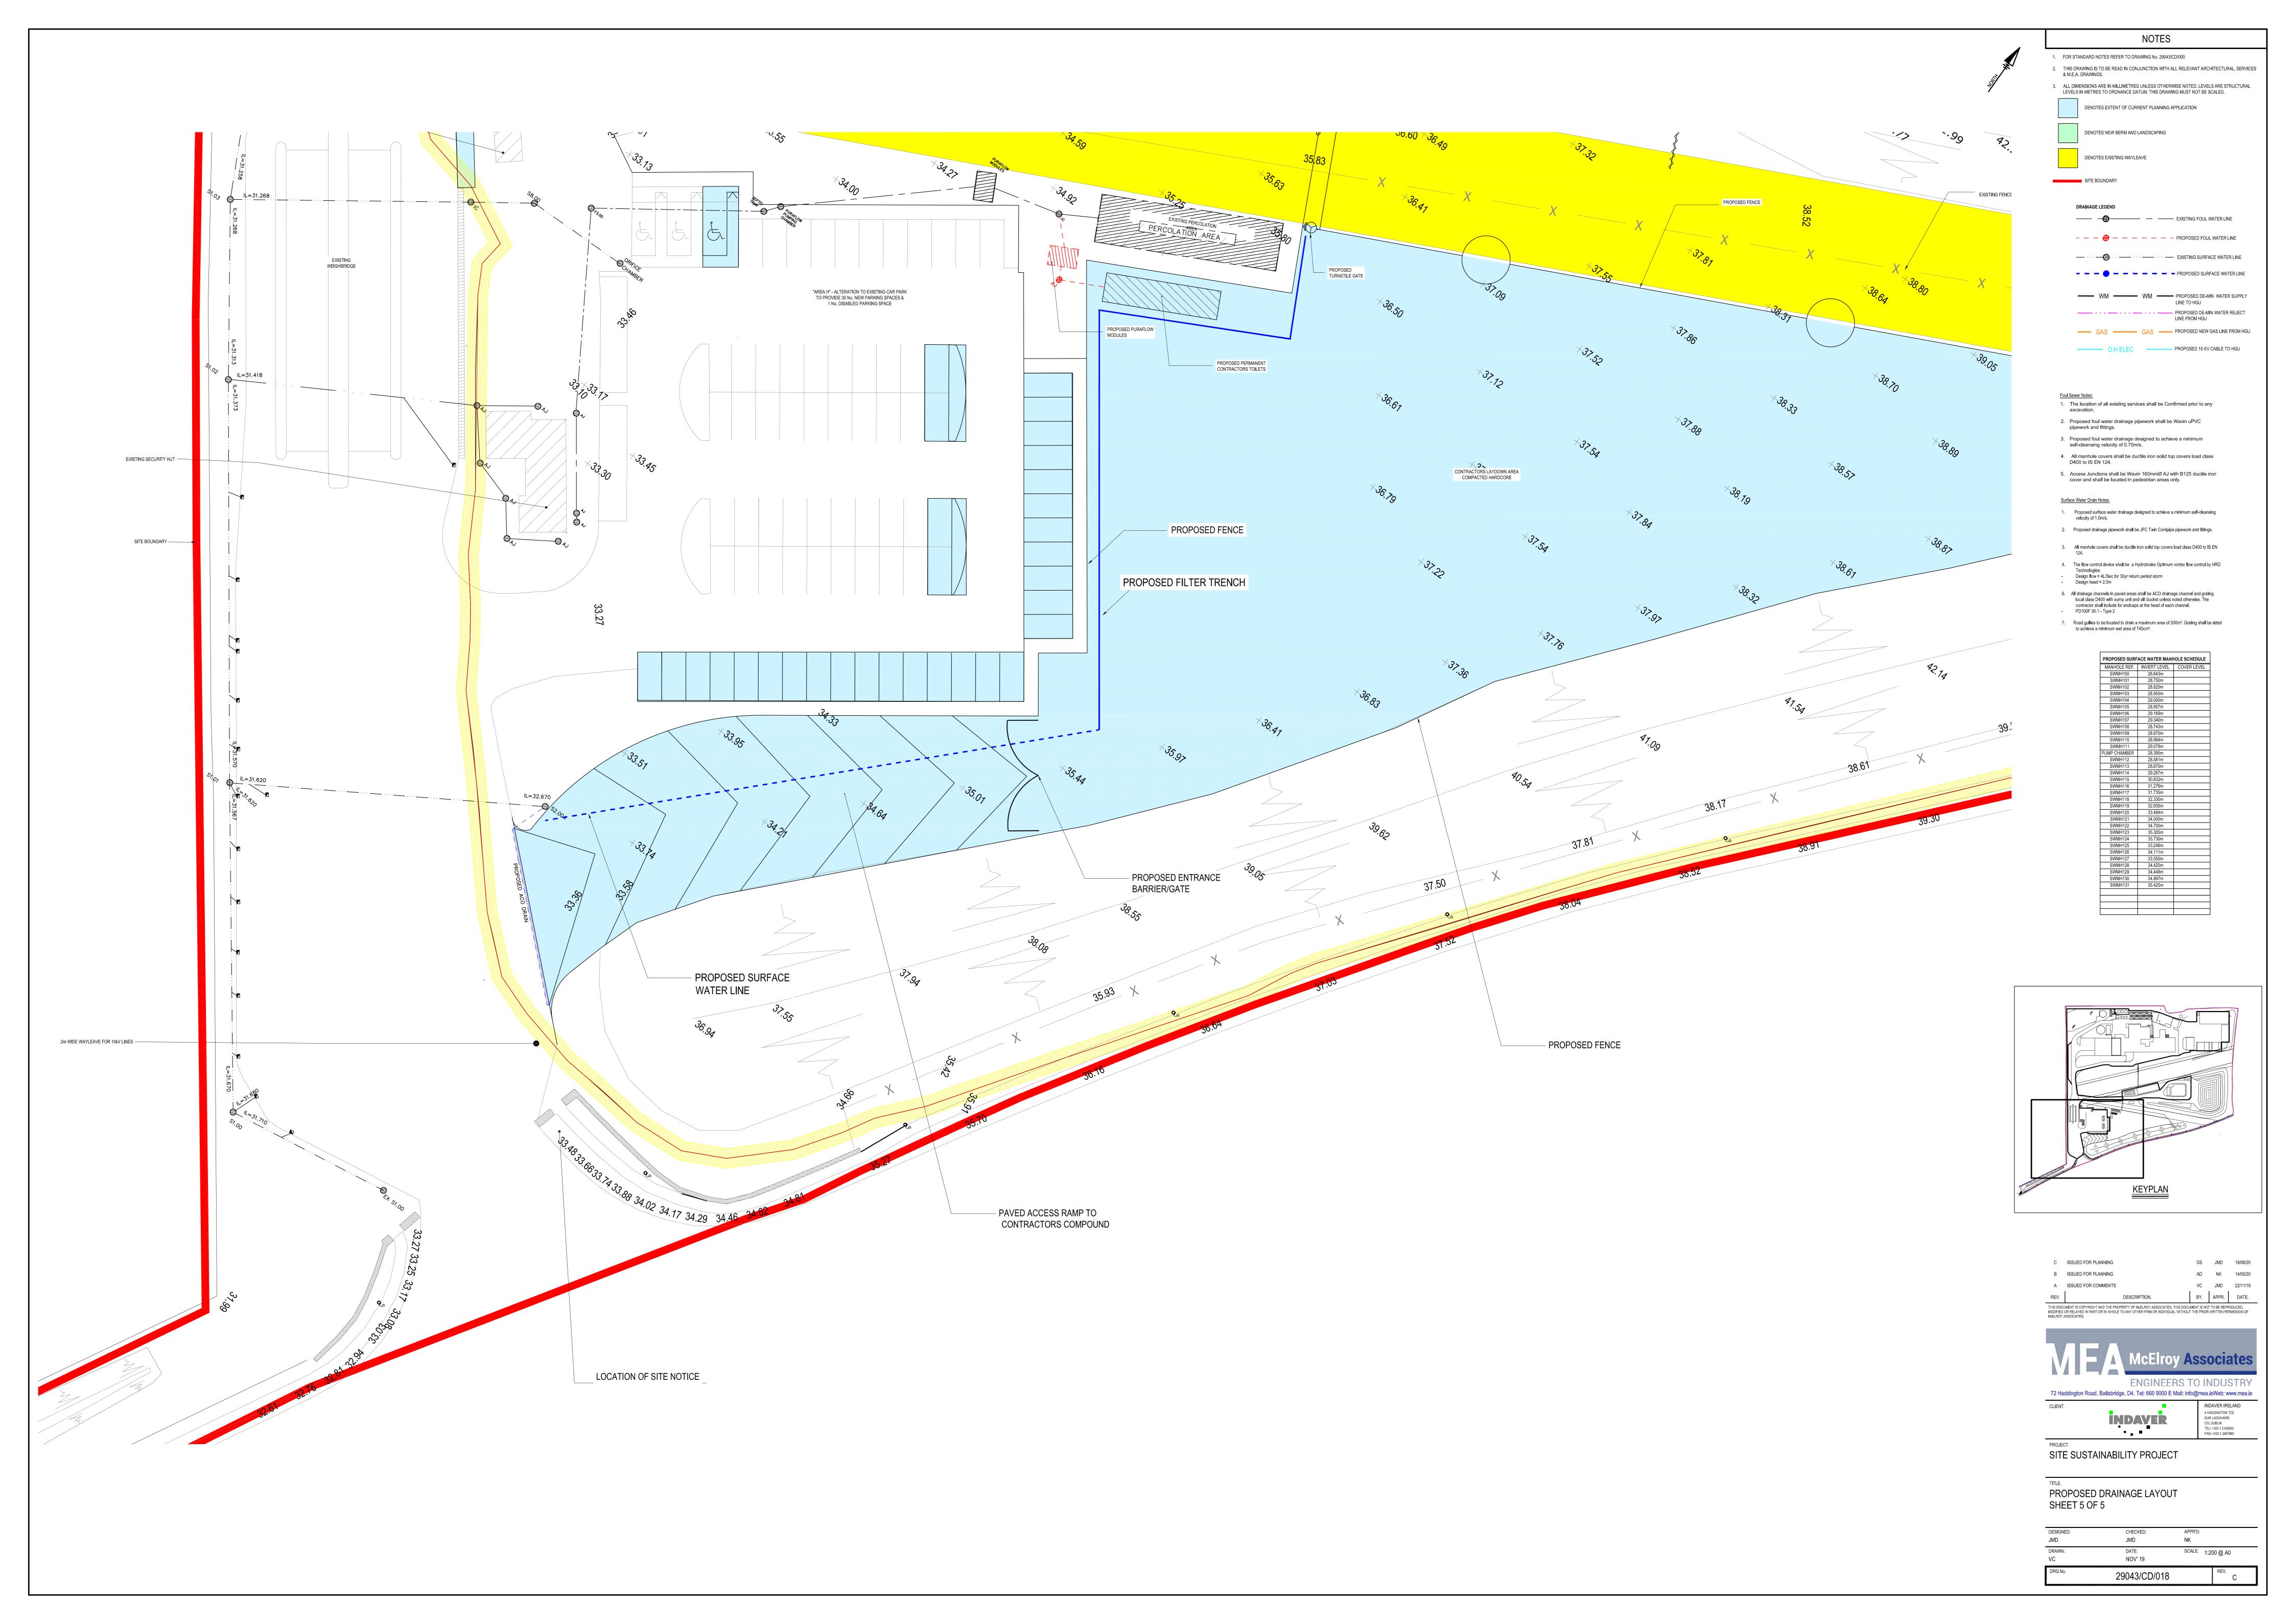
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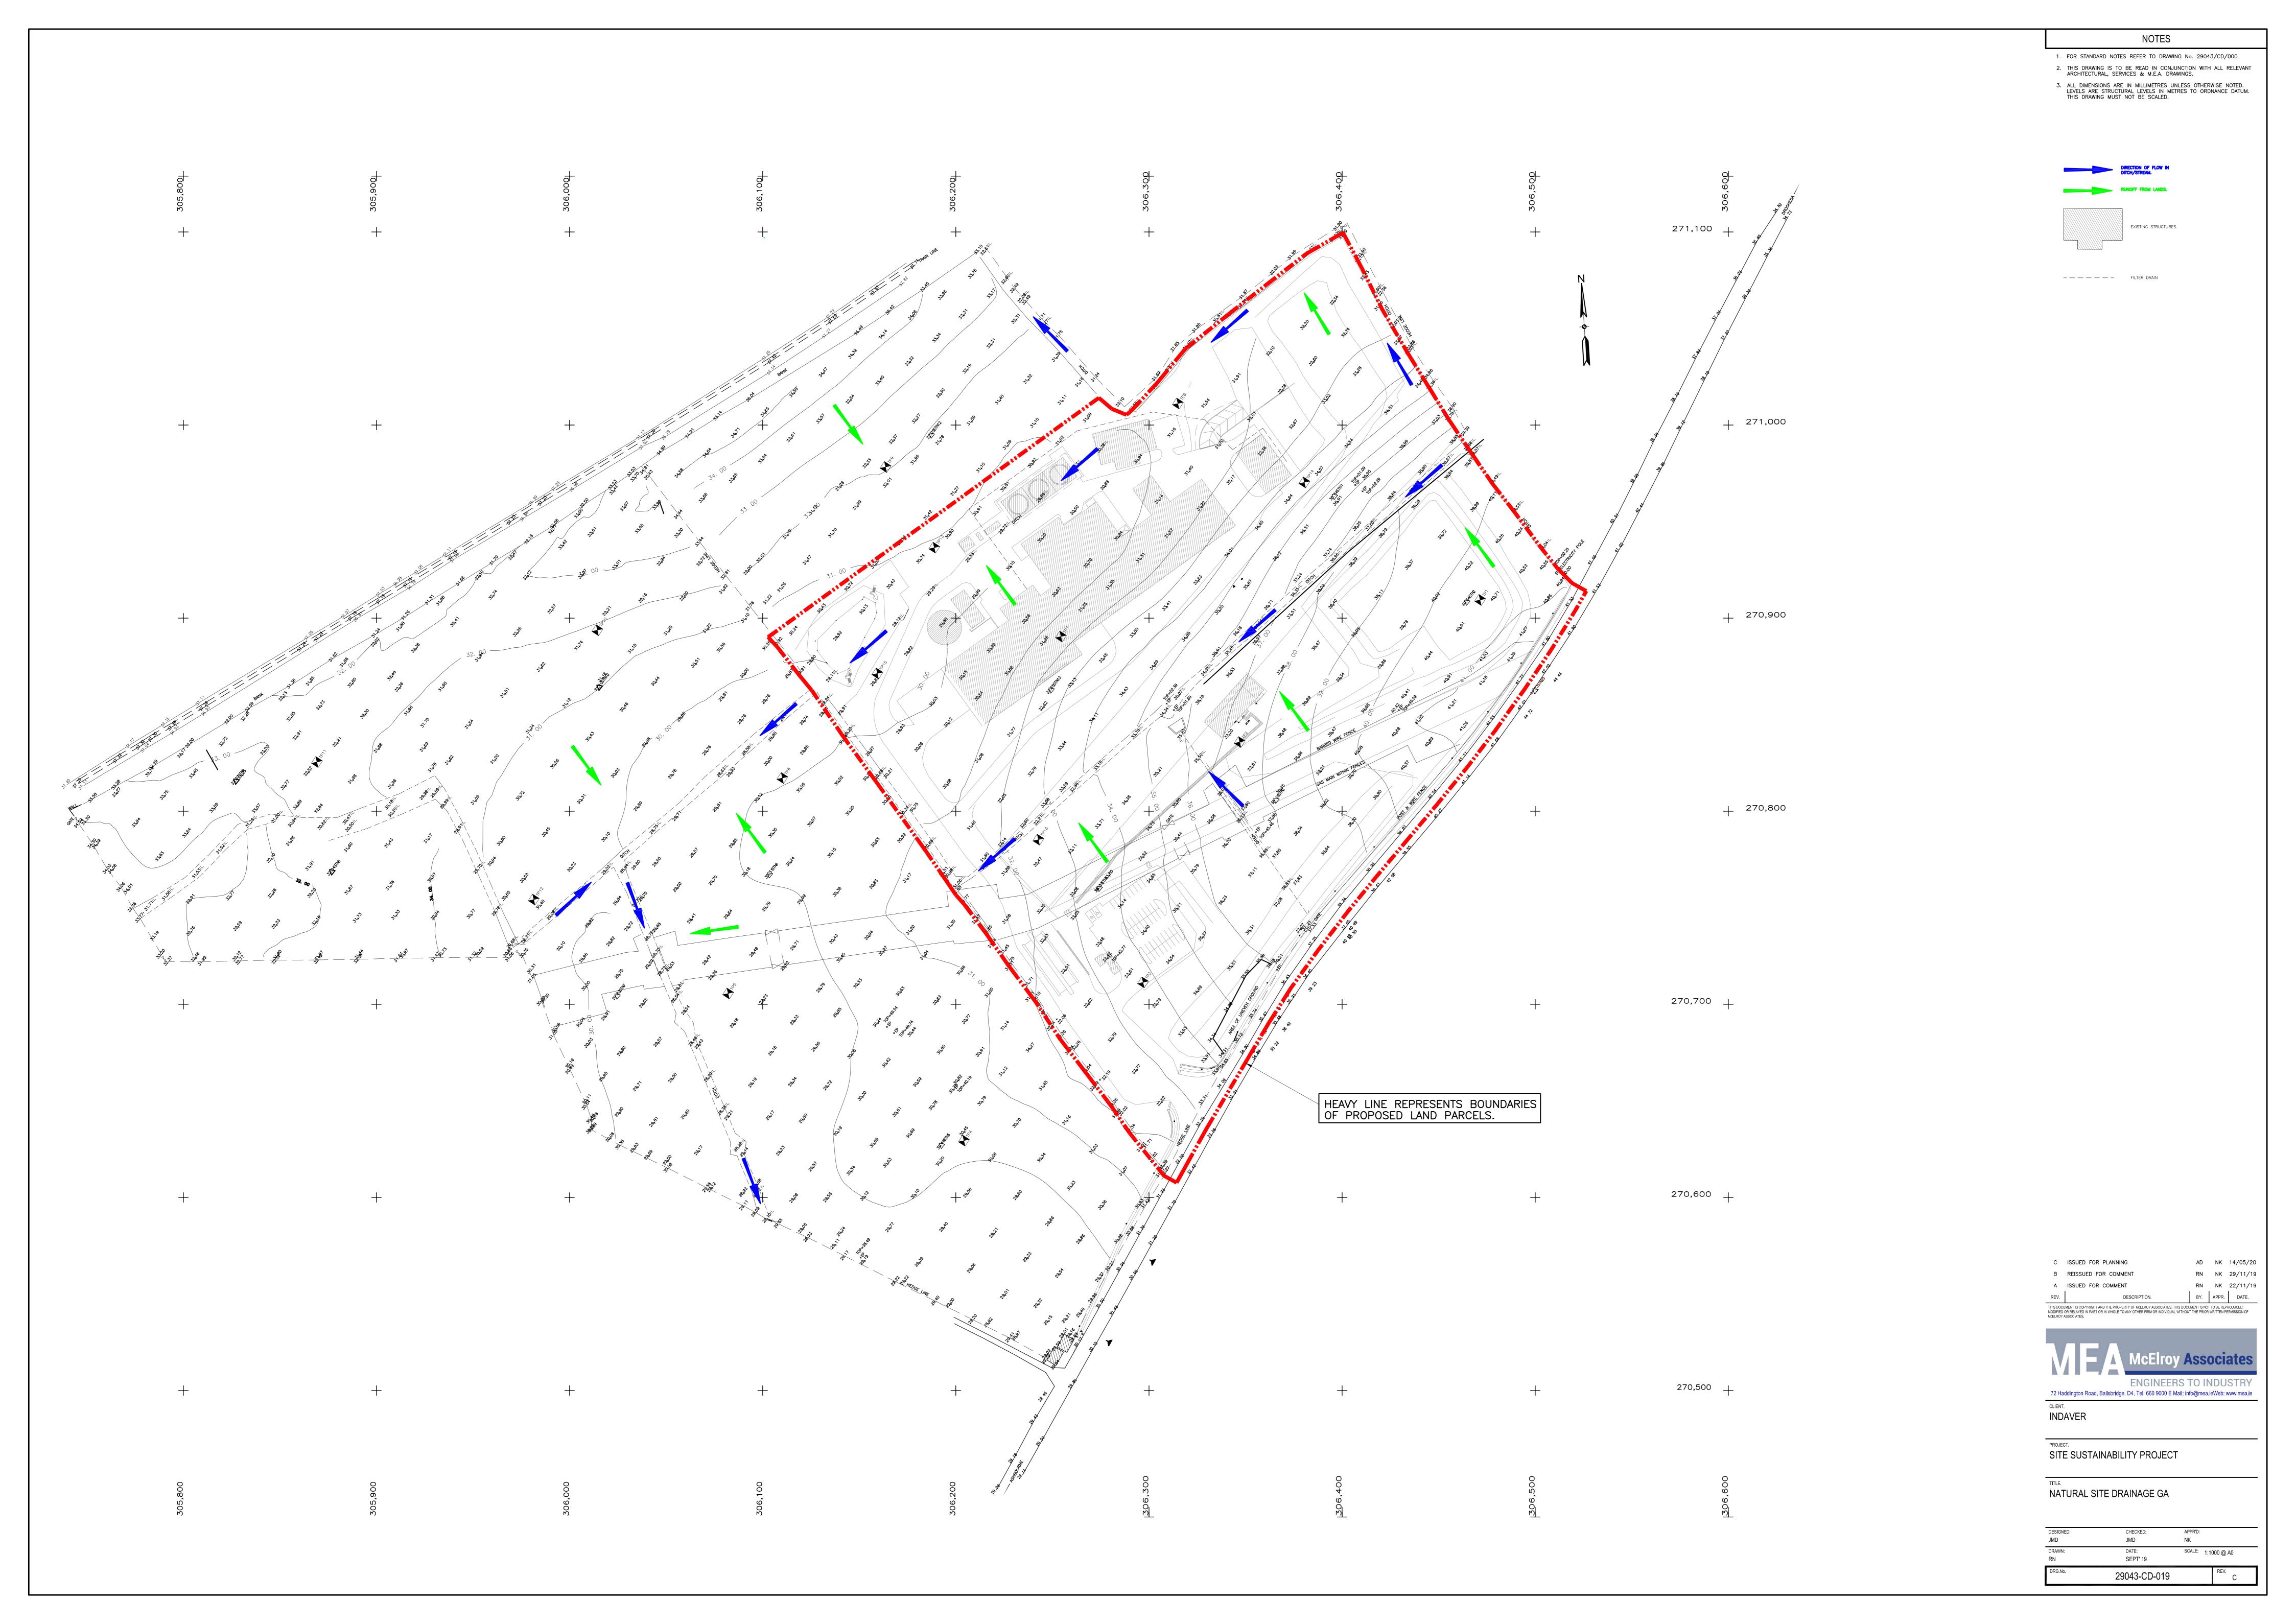
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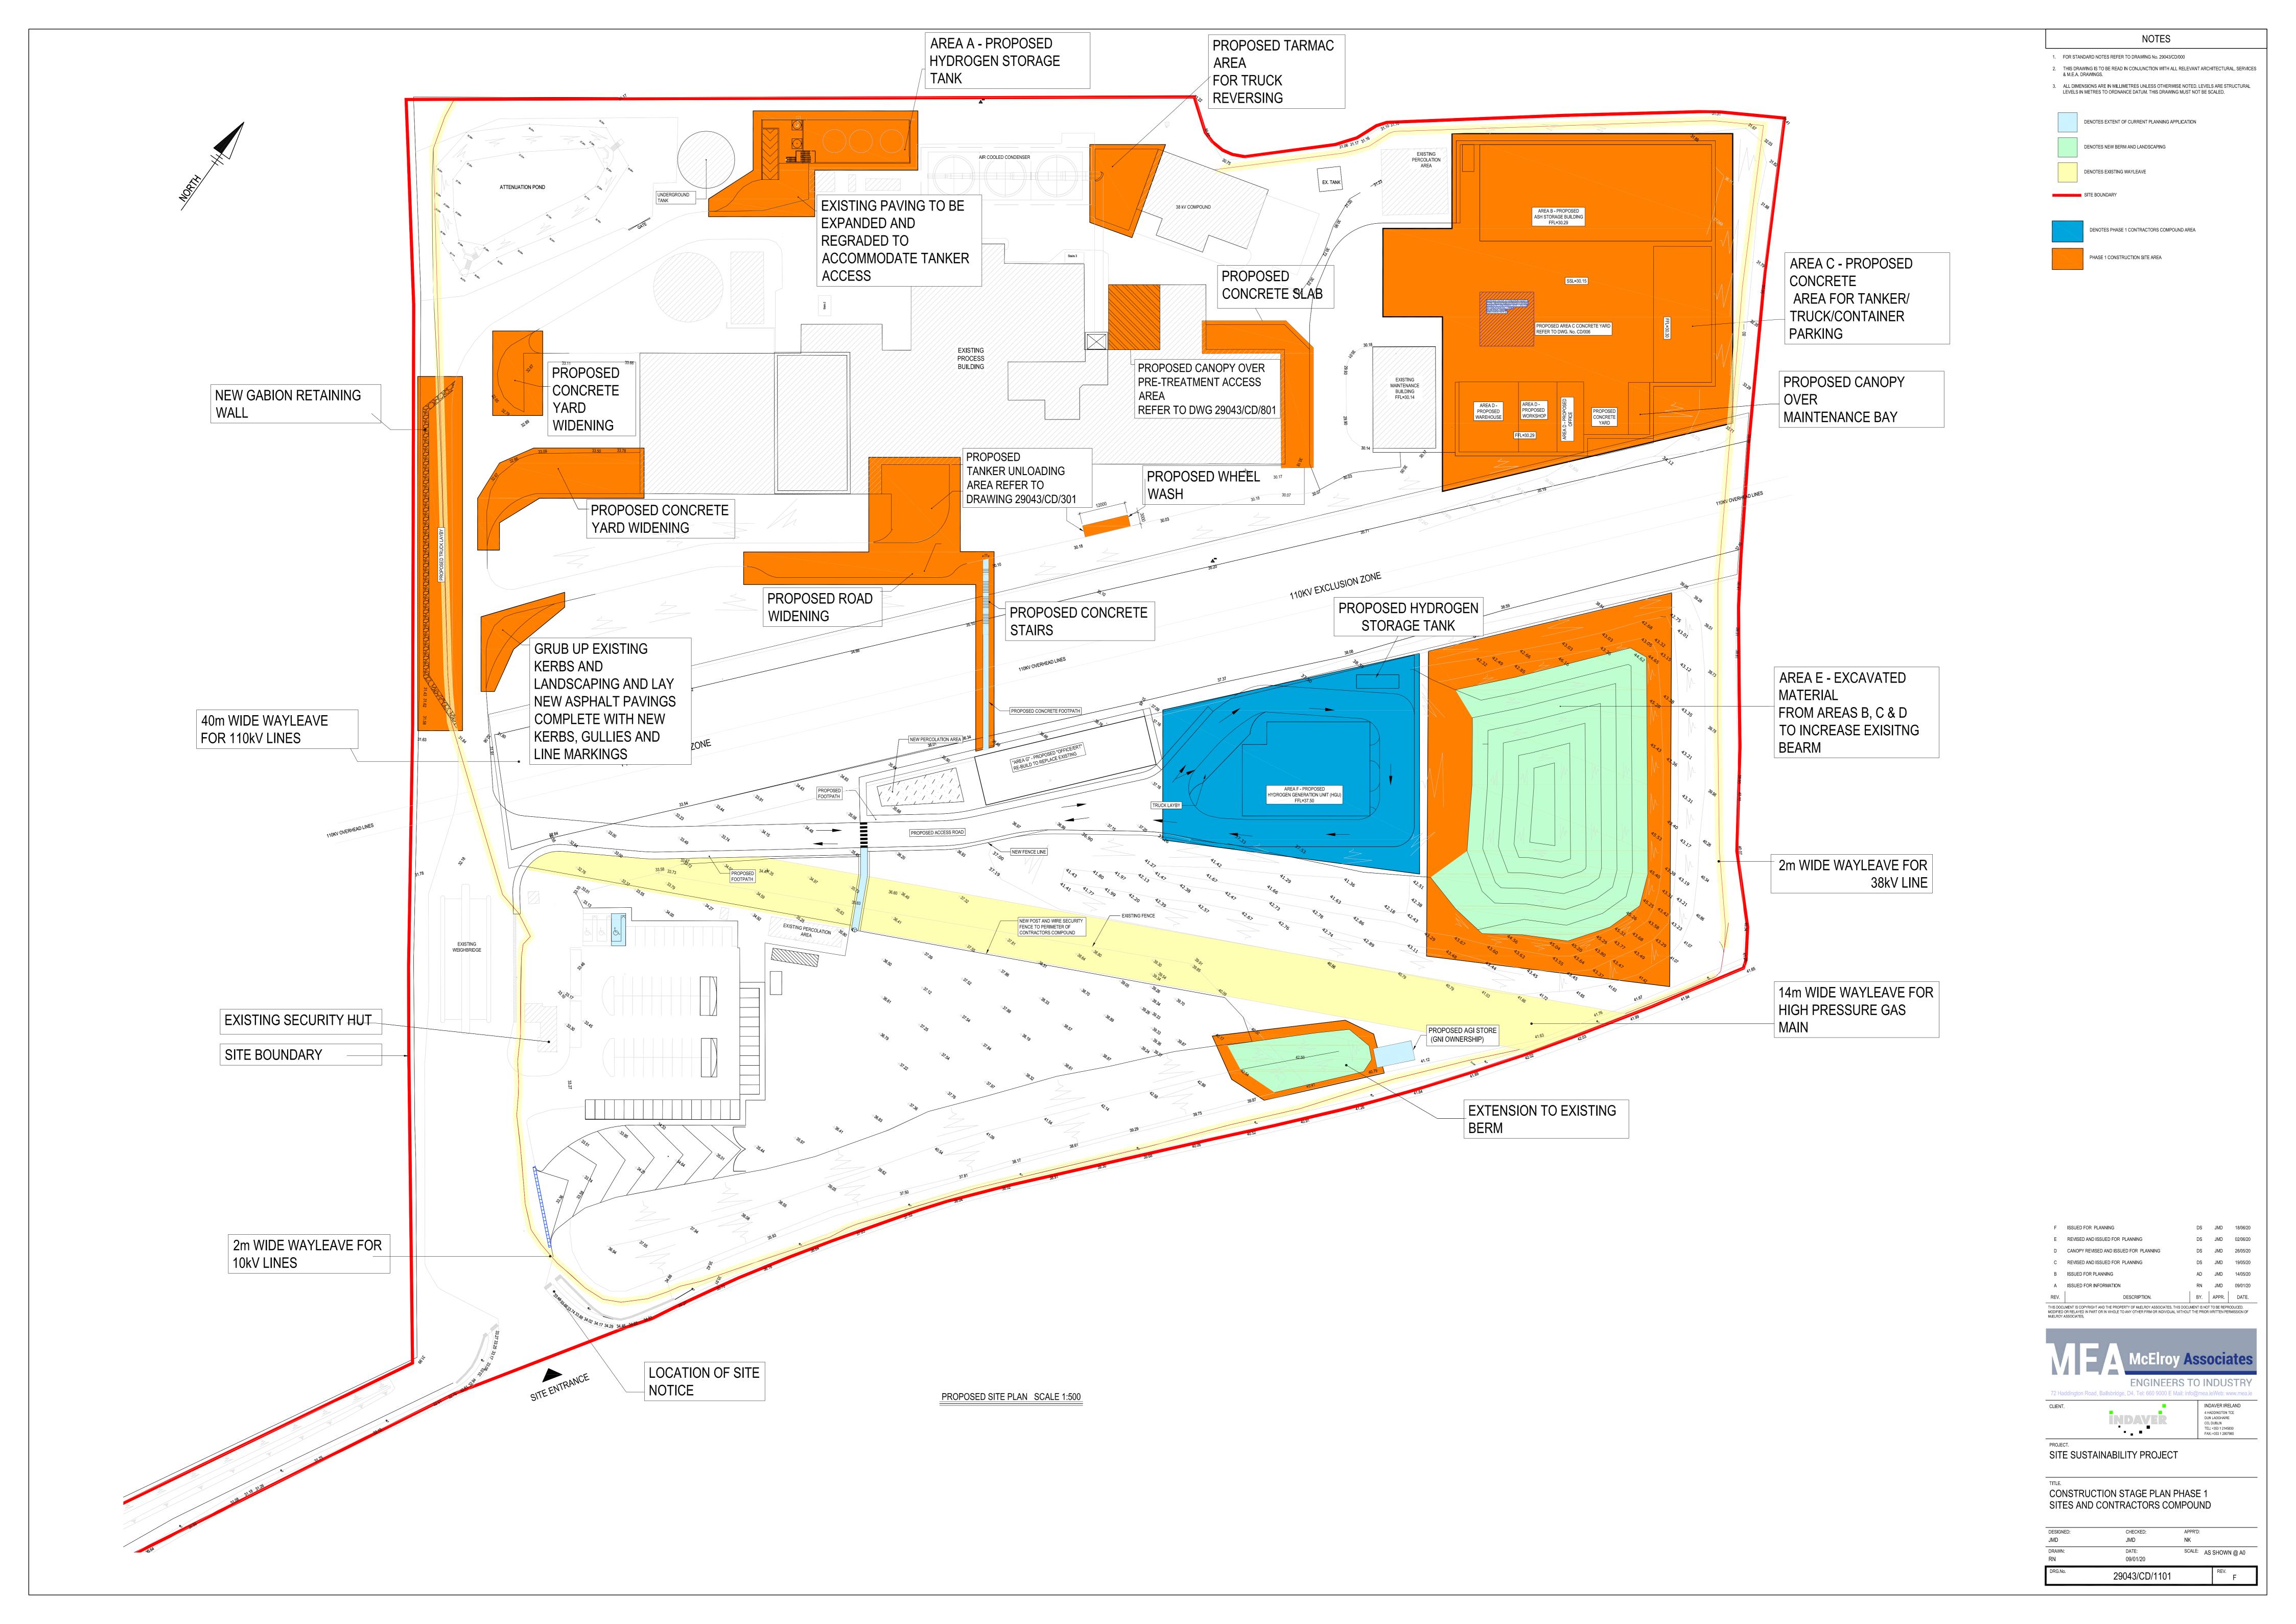

















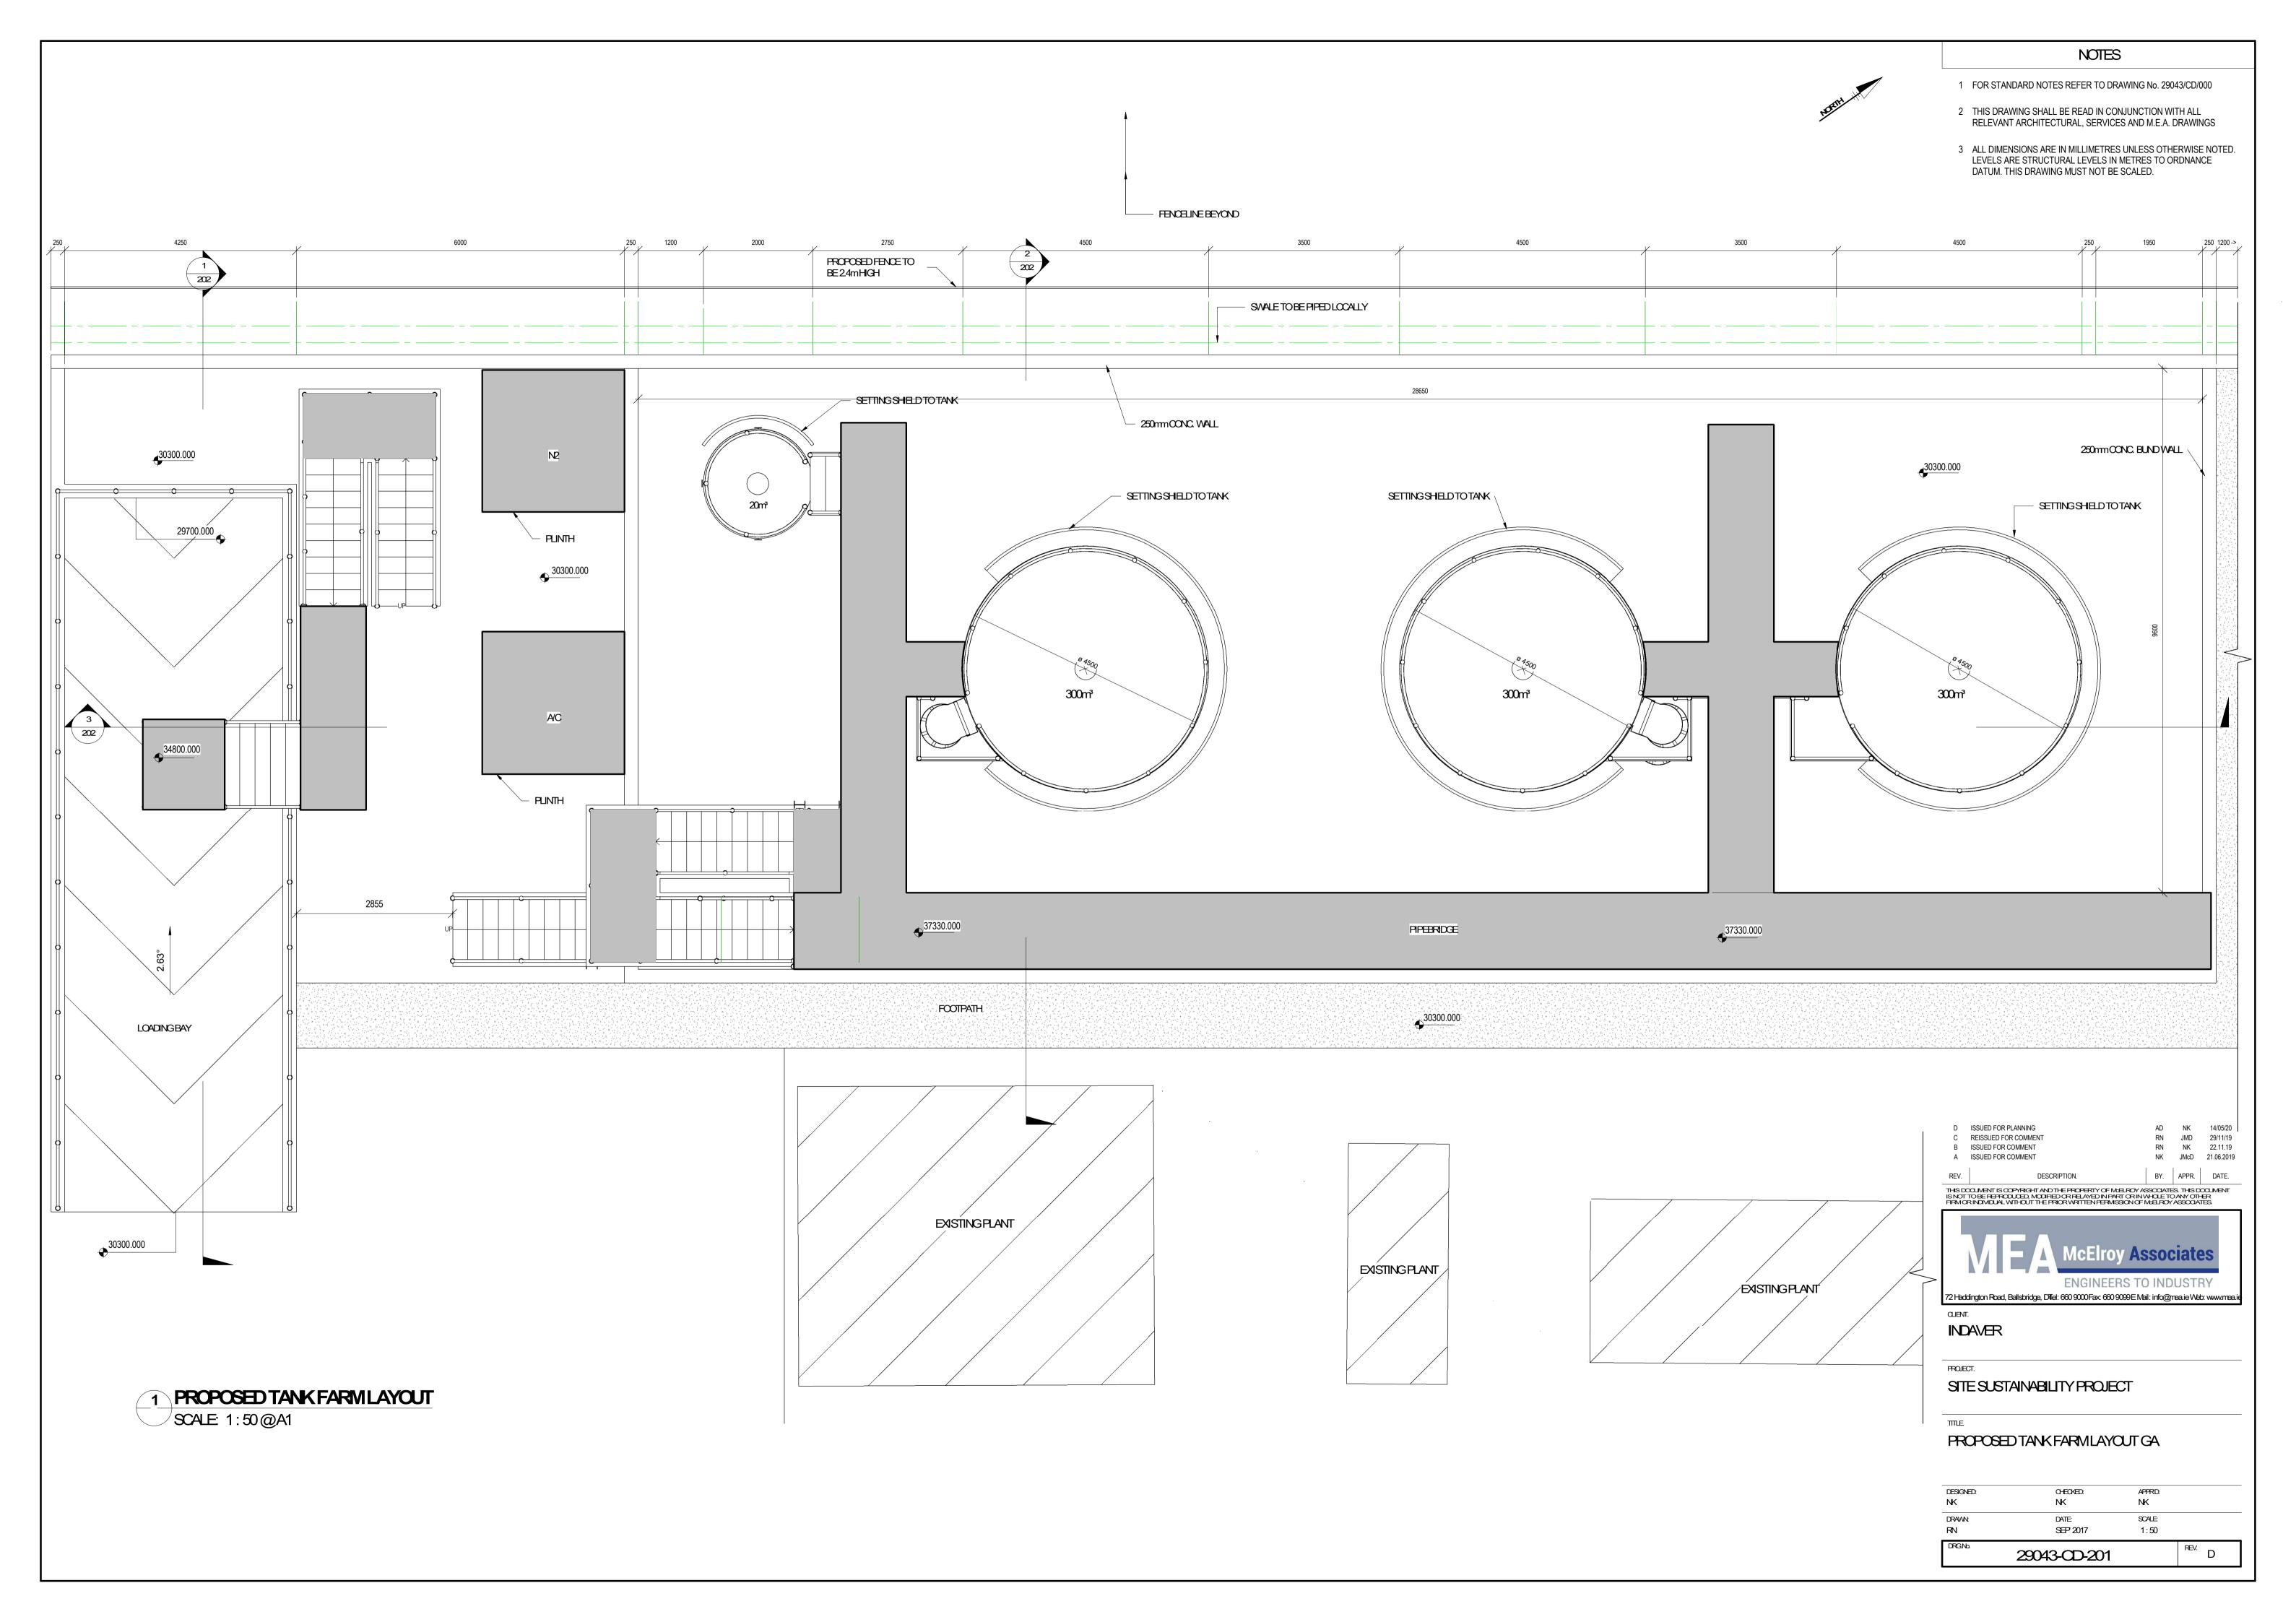

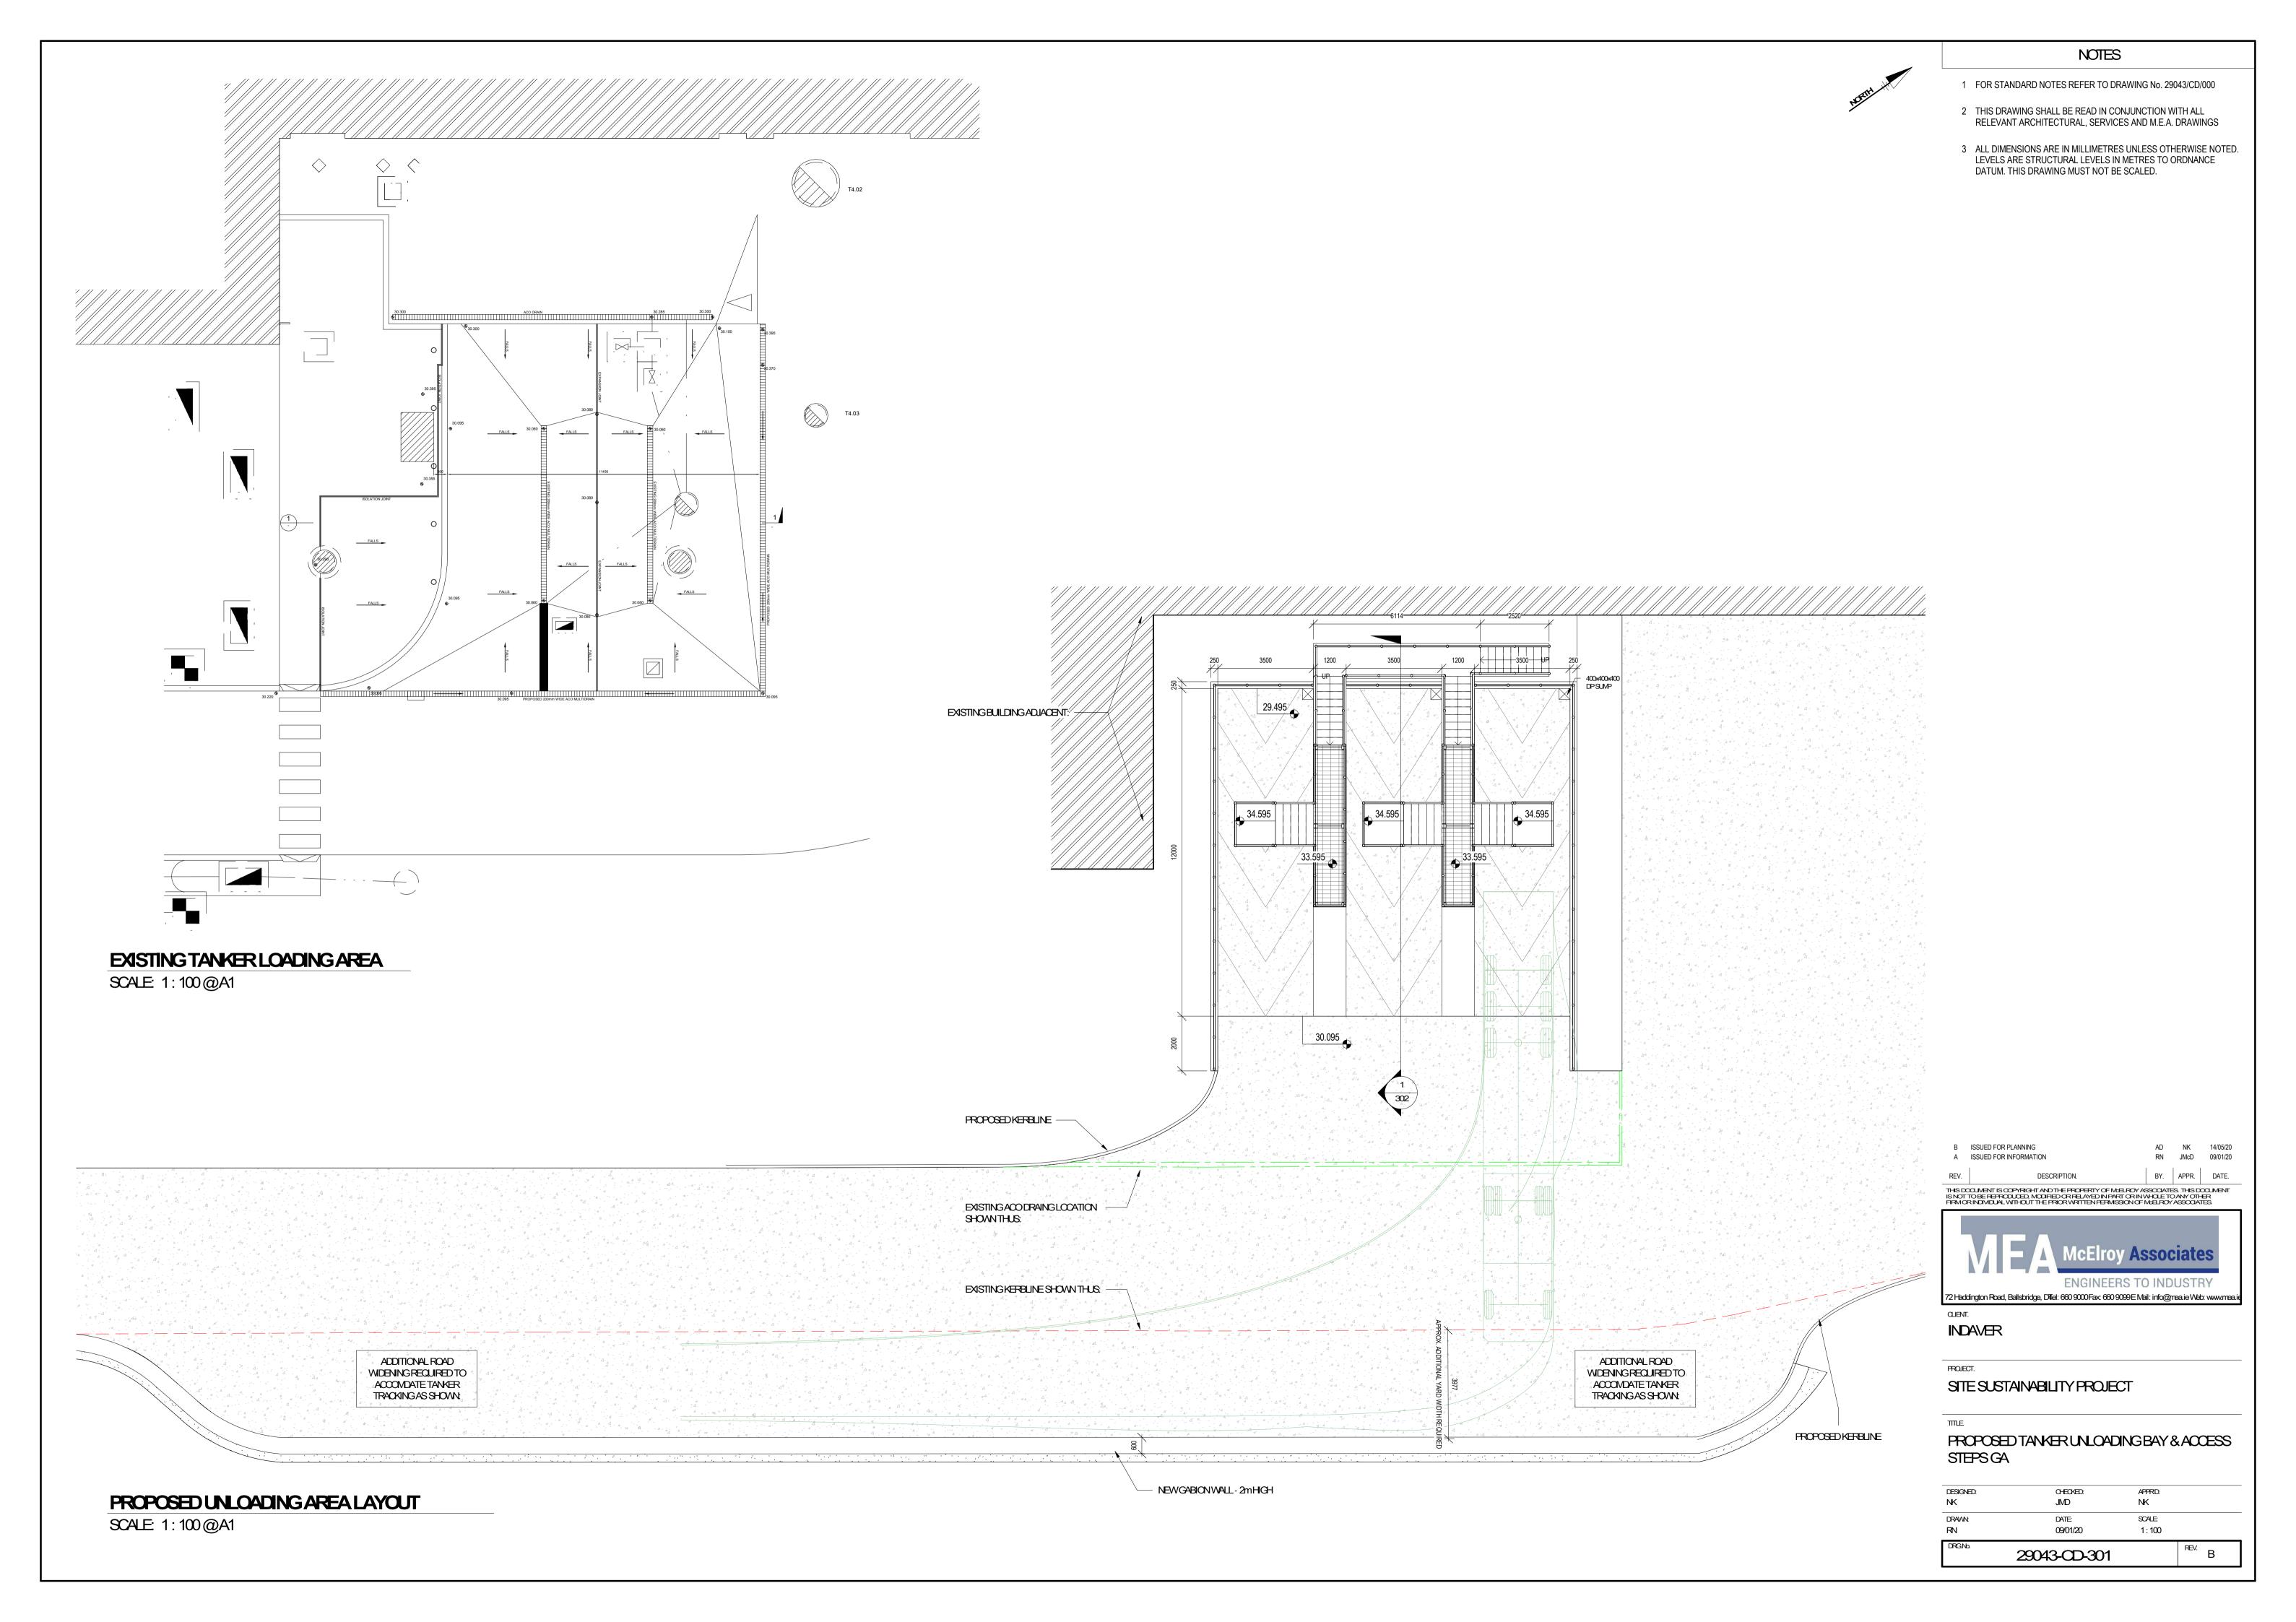

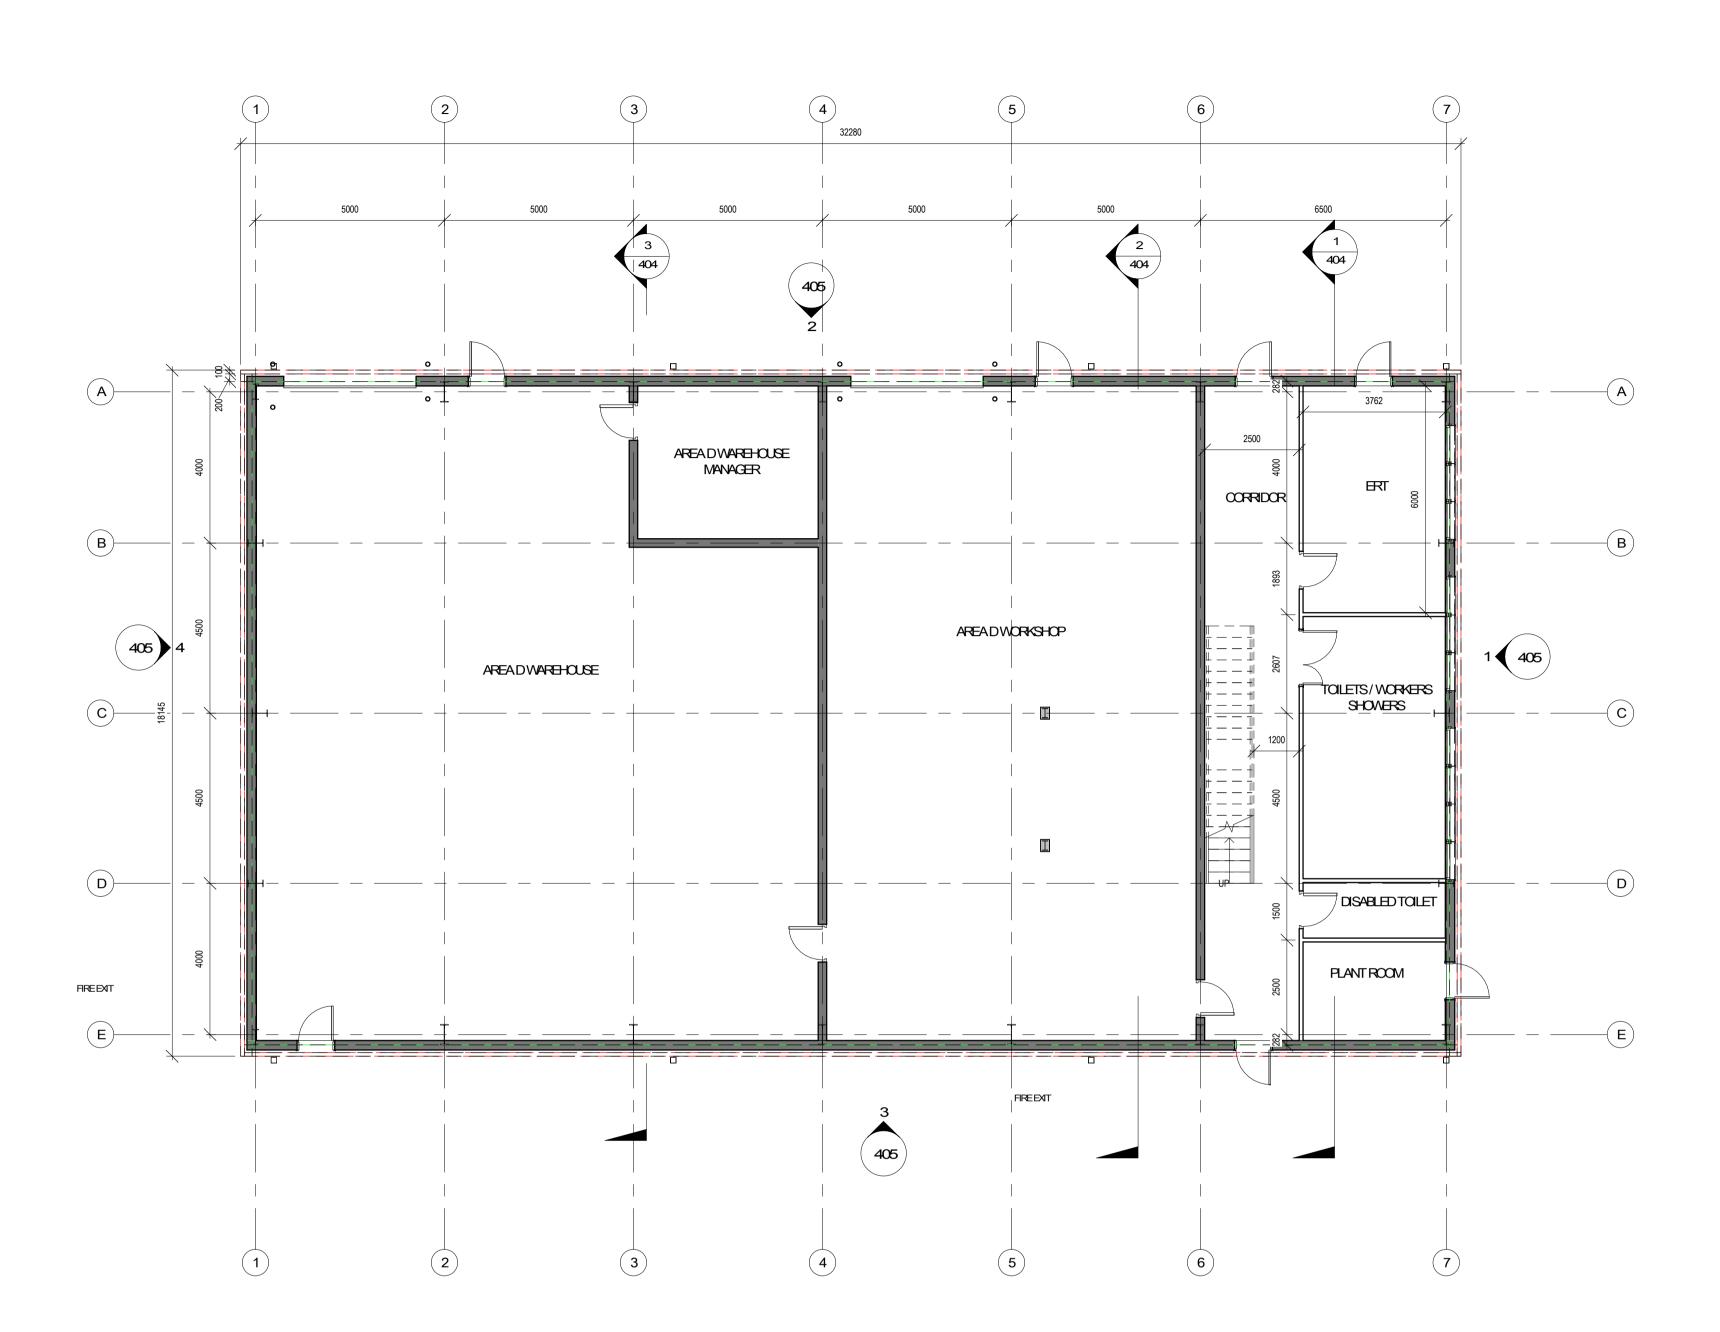

PROPOSED WAREHOUSE, WORKSHOP & 1 OFFICE/ERT GROUND FLOOR GA

- SCALE: 1:100@A1

MATERIAL LEGEND

- ALL CLADDING AND ROOFING TO BE POWDER COATED KINGSPANKS 1000 RWECO SAFE KAKI GREEN RAL 6013.
- ALL VERTICAL AND HORIZONTAL FLASHING TO BE PRESSED METAL WITH FINISHTOMATCH CLADDING-KAKI CREEN RAL 6013.
- 3. POLYCARBONATE TRANSLUCENT SHEETING.
- 4. POWDER COATED METAL DOOR COLOUR ANTHRACITE GREY RAL7016.
- METAL POWDER COATED LOUVERS COLOUR ANTI-PRACTIE GREY
- 6. INSULATED METAL ROOF COMERING-KAKI GREEN RAL 6013.
- . GUTTERS AND DOWNPIPES TO BE ANTI-RACITE GREY RAL7016.
- 8. ALL EXPOSED STRUCTURAL STEEL TO BE GALVANISED.
- 9. EXPOSED WALLING TO BE FINISHED WITH CAST-IN-PLACE CONCRETE/ PLASTERBLOCKWORK

NOTES



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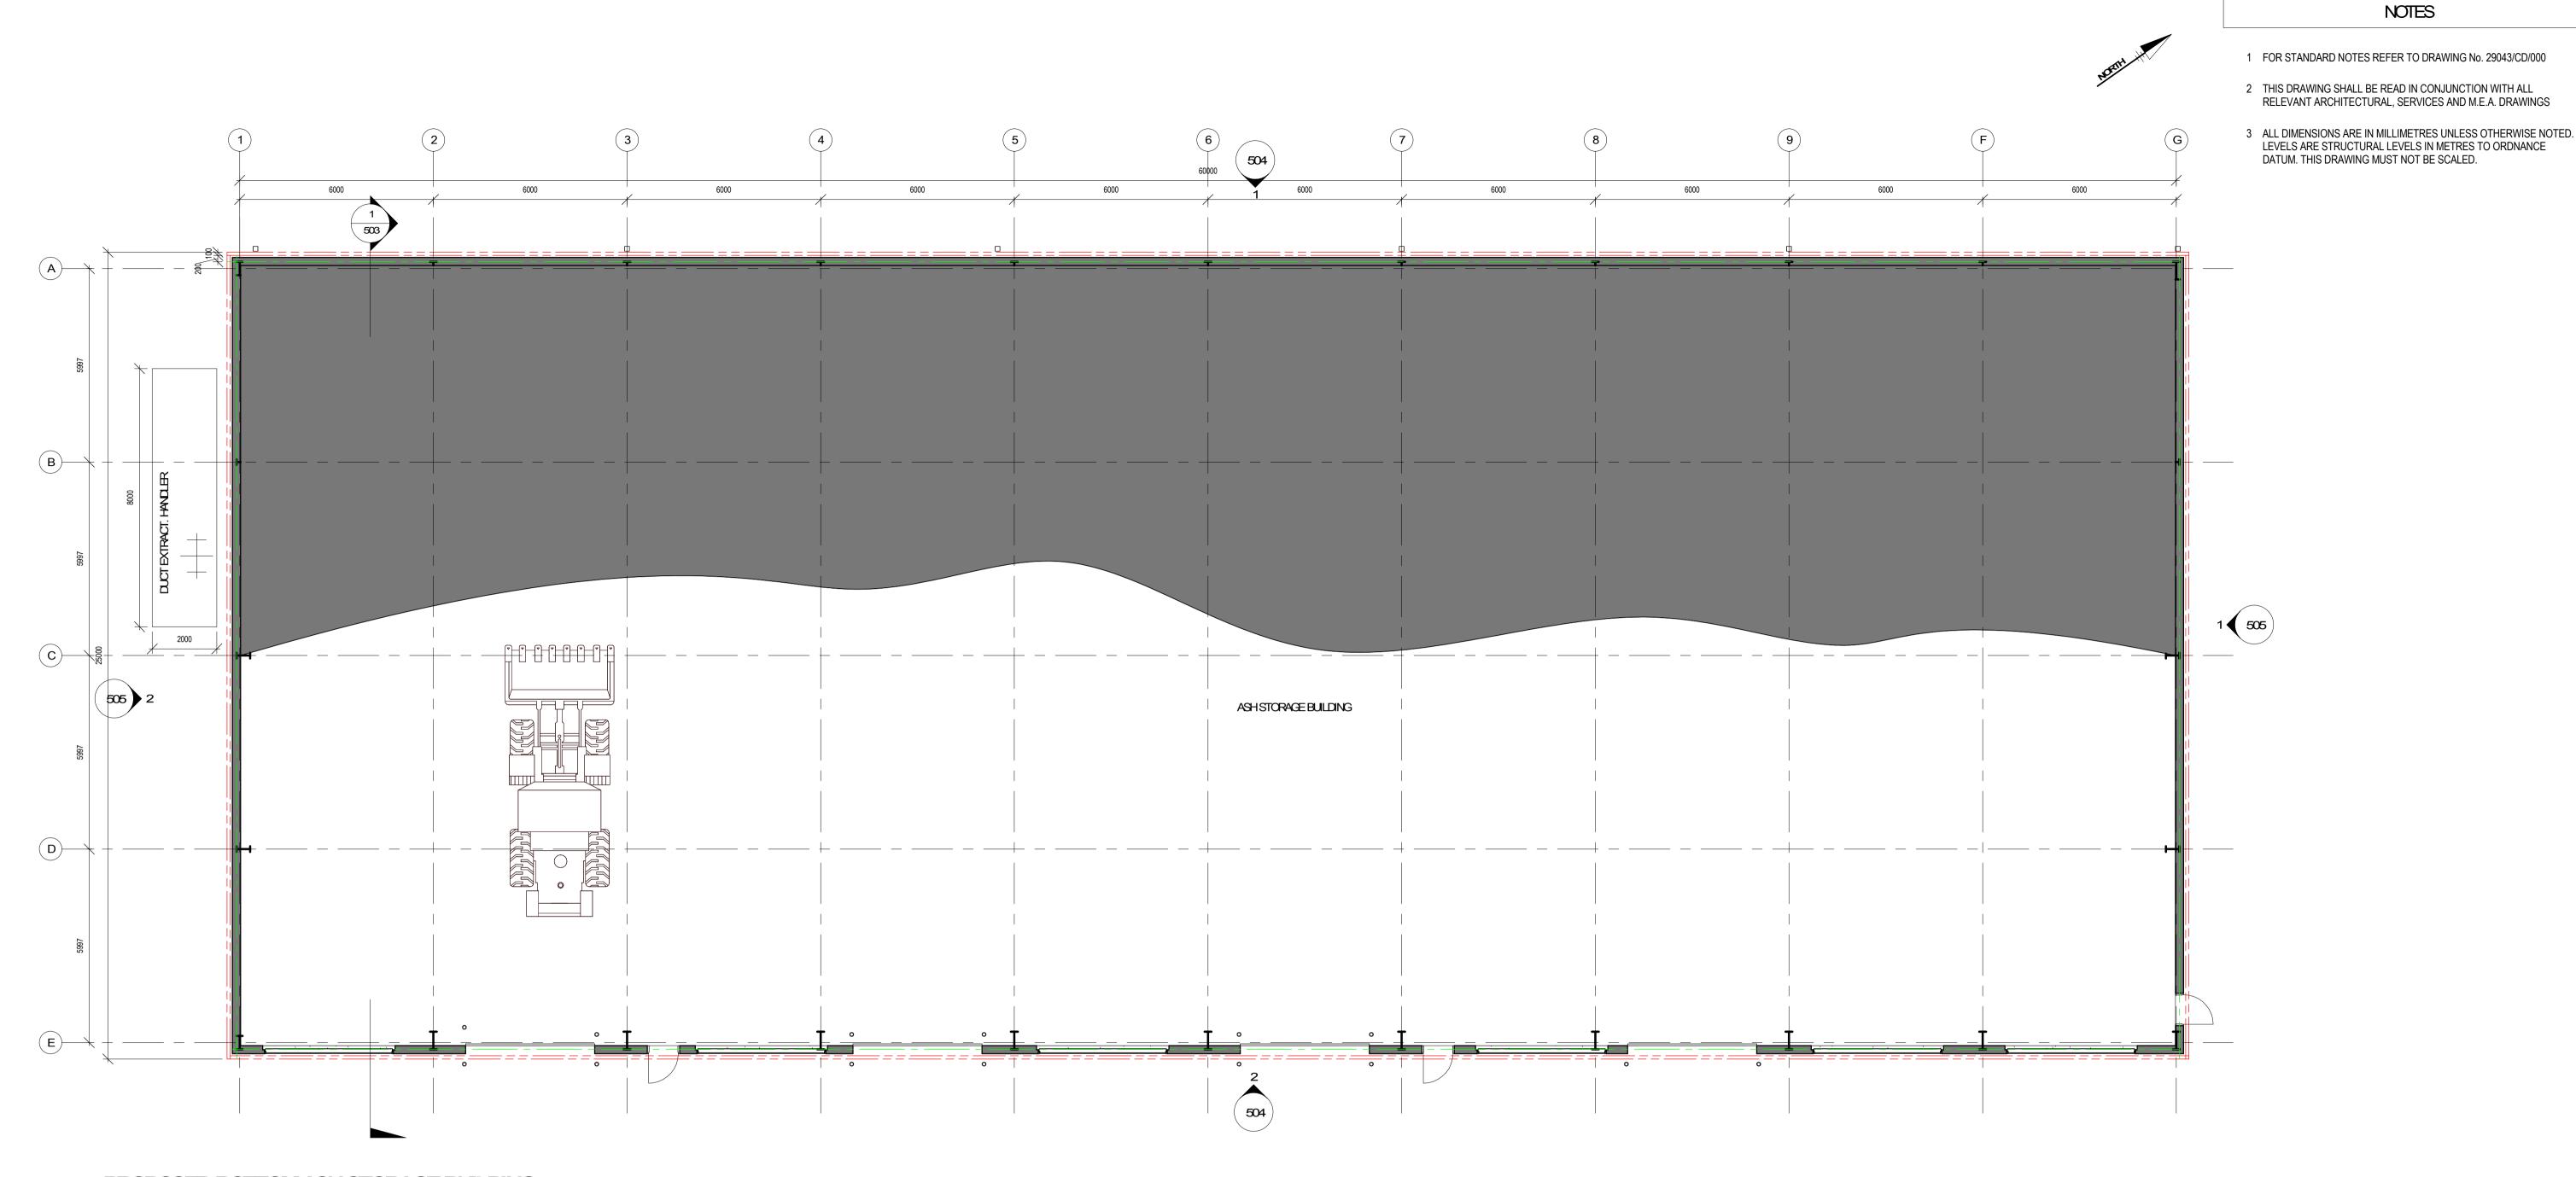
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SITE SUSTAINABILITY PROJECT

PROPOSED WAREHOUSE, WORKSHOP & OFFICE/ERT GROUND FLOOR GA

DESIGNED: CHECKED: APPRD: JMbD SEPT 19 As indicated 29043-CD-401



PROPOSED BOTTOM ASH STORAGE BUILDING **GROUND FLOOR GA**

SCALE: 1:100@A1

MATERIAL LEGEND

- ALL CLADDING AND ROOFING TO BE POWDER COATED KINGSPANKS 1000 RWECO SAFE KAKI CREEN RAL 6013. . ALL VERTICAL AND HORIZONTAL FLASHING TO BE PRESSED METAL WITH FINISH TO MATCH CLADDING - KAKI CREEN RAL 6013. POLYCARBONATE TRANSLUCENT SHEETING . POWDER COATED METAL DOOR - COLOUR ANTI-PRACITE GREY RAL7016.
- METAL POWDER COATED LOUVERS COLOUR ANTI-RACITE GREY RAL7016.
- 6. INSULATED METAL ROOF COVERING-KAKI CREEN RAL 6013.
- . GUTTERS AND DOWNPIPES TO BE ANTHRACITE GREY RAL7016.
- 8. ALL EXPOSED STRUCTURAL STEEL TO BE GALVANISED.
- 9. EXPOSED WALLING TO BE FINISHED WITH CAST-IN-PLACE CONCRETE/ PLASTER BLOCK WORK

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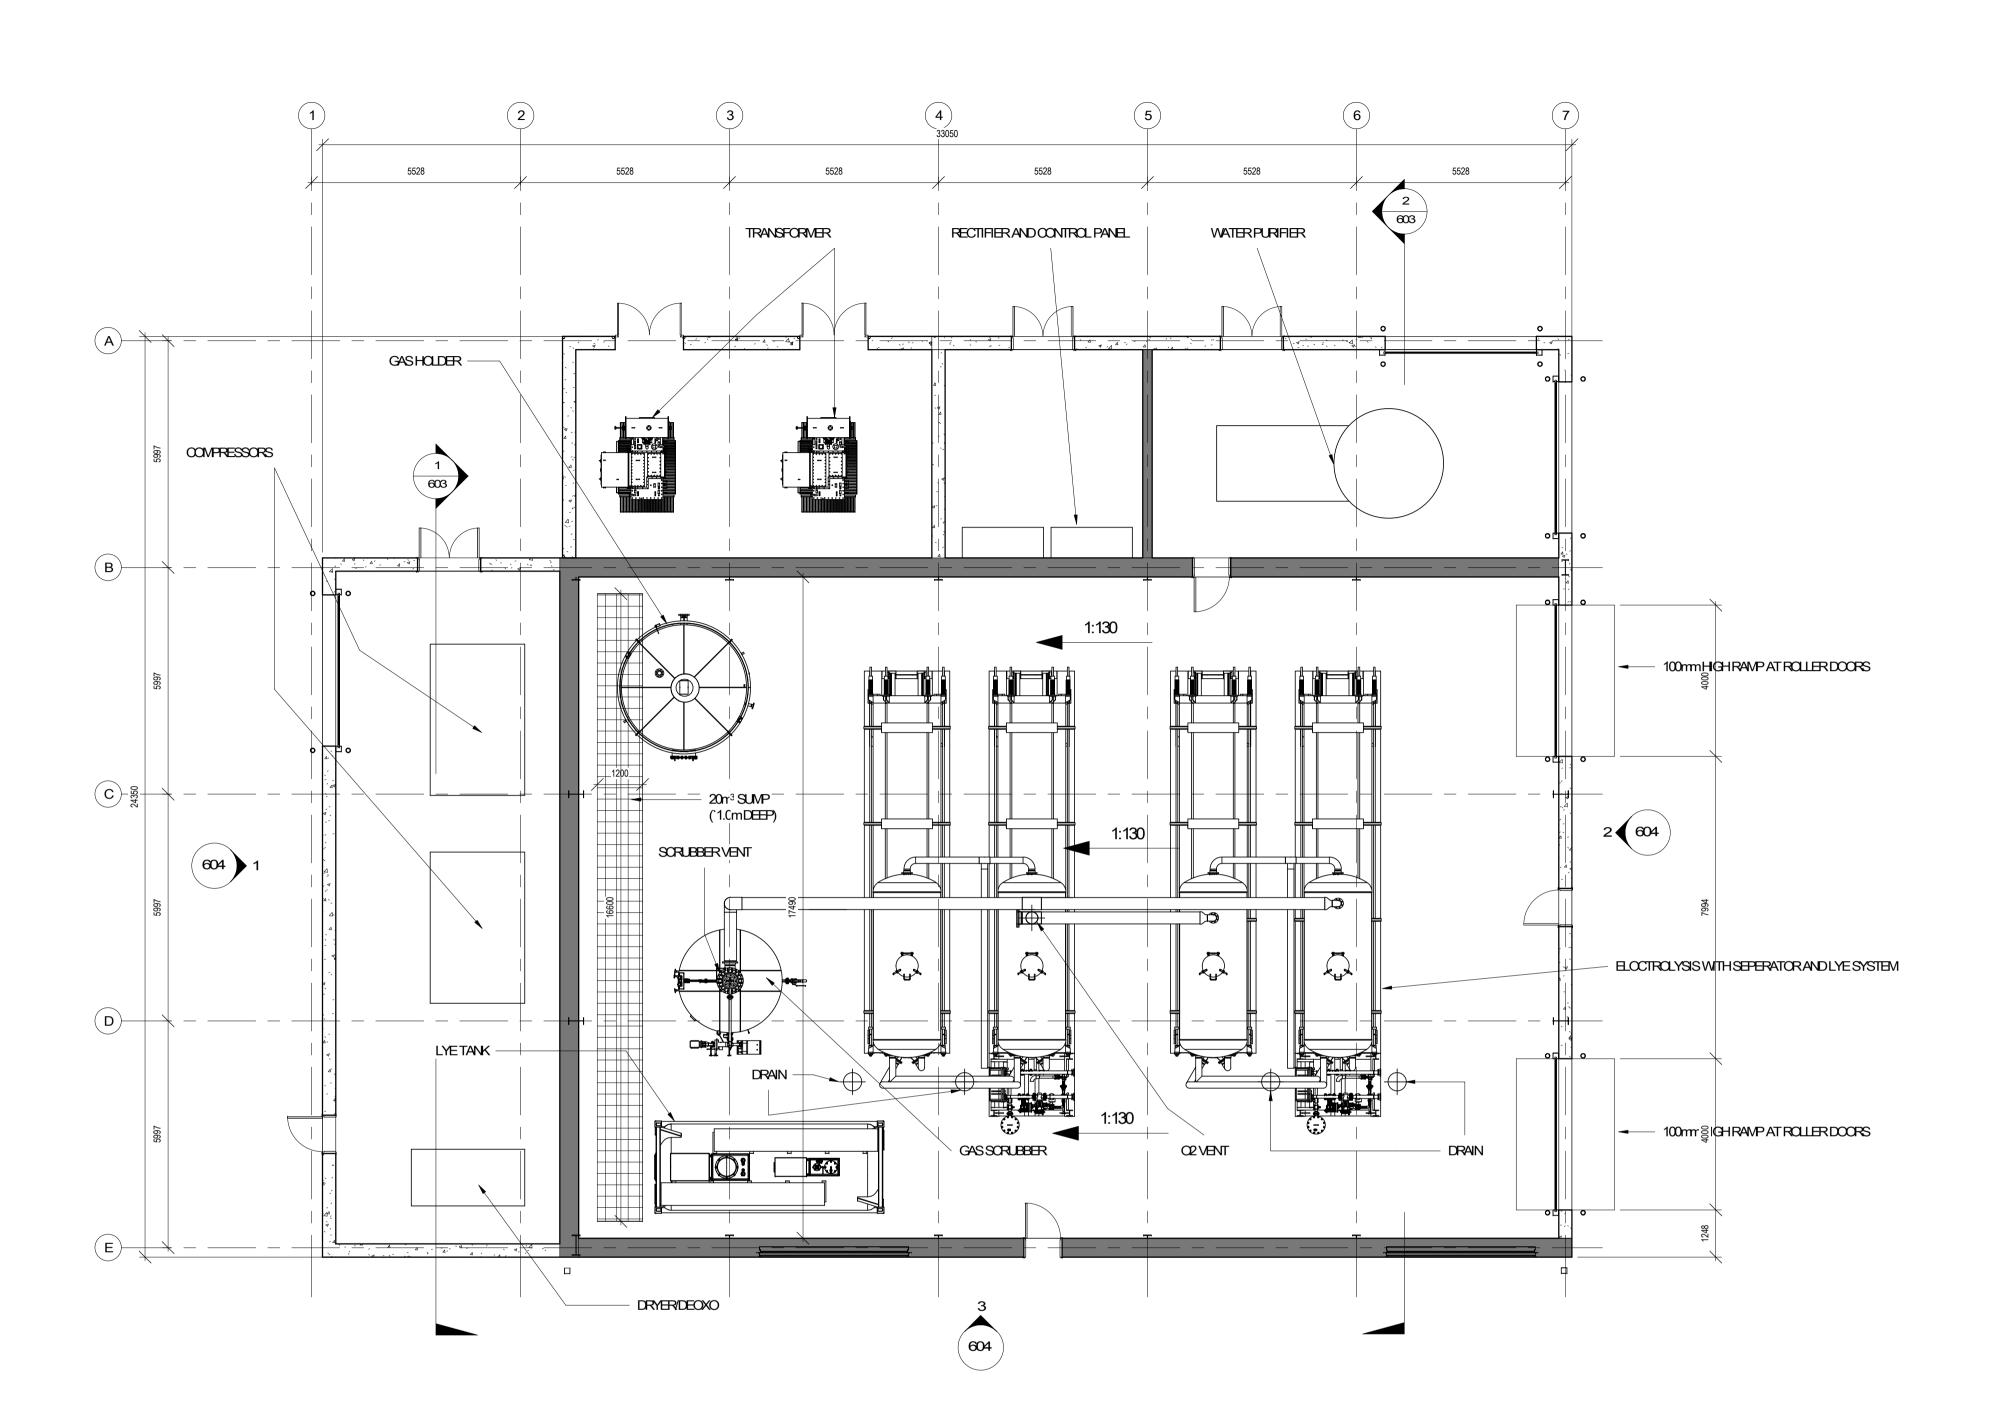
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SITE SUSTAINABILITY PROJECT

PROPOSED BOTTOMASH STORAGE BUILDING GROUNDFLOORGA

DESIGNED: CHECKED: APPRD: JMbD JMbD SEPT 19 As indicated 29043-CD-501



PROPOSED HYDROGEN GENERATION UNIT (HGU) BUILDING- GROUND FLOOR GA

SCALE: 1:100@A1

NOTES

- 1 1/1
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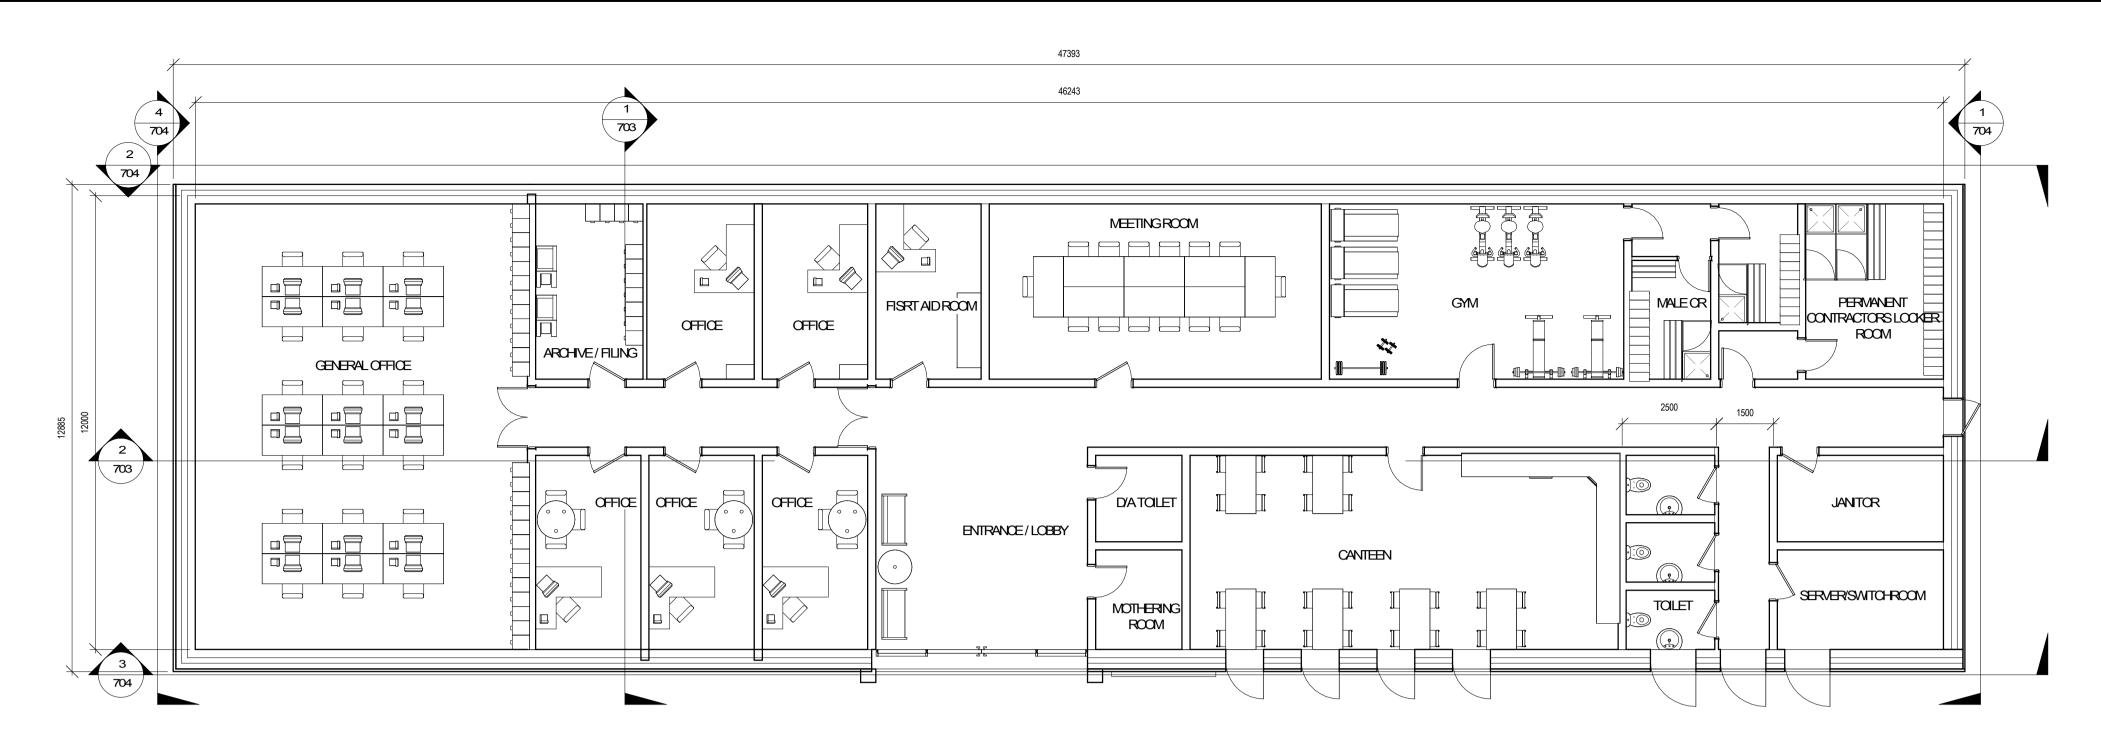
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PROJECT.

SITE SUSTAINABILITY PROJECT

PROPOSED HYDROGEN GENERATION UNIT (HGU)
BUILDING GROUND FLOOR GA

DRG.No.	29043-CD-601		REV.
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GROUND FLOOR PLAN GA

SCALE: 1:100@A1

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SITE SUSTAINABILITY PROJECT

PROPOSED OFFICE REBUILD - GROUND FLOOR

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DRAWN:	DATE:	SCALE	
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DRG.Nb.	29043-CD-701		REV. C

